# — 3" RADIUS CORNERS **CAMERON COUNTY** SANTA ROSA PARK **IMPROVEMENTS** — 1/2" BORDER LINES Commissioner Pct. 3 David A. Garza Cameron County Administration Parks Director SSP Designs, LLC. 4" X 4" BRACE TOP & BOTTOM -- 4" X 4" POST 01 PROJECT SIGN



### D R A W I N G INDEX

### CIVIL DRAWINGS:

EXISTING SITE/ DEMOLITION PLAN

# LANDSCAPE DRAWINGS:

LANDSCAPE SCHEDULES AND DETAILS

LANDSCAPE PLAN

# ARCHITECTURAL DRAWINGS: COVER

D1.01

A1.01

A1.02

A1.03

A2.01

A2.02

A3.01

A4.01

COVER SHEET	EP1.1	ELECTRICAL/PLUMBING SITE PLAN
DEMOLITION PLAN	E2.1	ELECTRICAL SCHEDULES; LEGENDS
SITE PLAN	E3.1	LIGHTING PLAN
SITE DETAILS	E4.1	SPORTS LIGHTING DETAILS; PANELS; RISER DIAGRAMS
BASEBALL FIELD PLAN; DETAILS	E5.1	LIGHTING DETAILS
BOYS & GIRLS CLUB GYMNASIUM PLAN	E5.2	ELECTRICAL DETAILS

DP2.1

P4.1

ELECTRICAL/PLUMBING:

C-5 EROSION CONTROL DETAILS C-6 DIMENSION SITE PLAN

EROSION CONTROL PLAN

C-7 GRADING PLAN

C-1 COVER SHEET

C-2 GENERAL NOTES

C-8 CIVIL DETAILS

# GOMEZ MENDEZ SAENZ, INC.

1150 PAREDES LINE RD. BROWNSVILLE, TX. 78521 PH. (956) 546-0110 FAX. (956) 546-0196

# STRUCTURAL ENGINEERS

BOYS & GIRLS CLUB GYMNASIUM PLAN

**BUILDING ELEVATIONS** 

WALL SECTIONS; DETAILS

SCHEDULES; DETAILS

# GREEN RUBIANO & ASSOCIATES

PH. (956) 428-4461 FAX (956) 428-0281

# MECHANICAL ENGINEERS

# ETHOS ENGINEERING - M.E.P.


(956) 230-3435 FAX: (956) 720-0830

REVISIONS

**GMS** ARCHITEC

1150 Paredes Line Rd Brownsville, (956) 546-0110 Fax (956) 546-0196



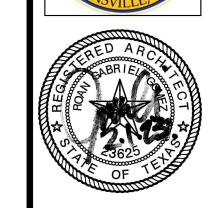

© Copyright 2023 Architects-Planners Interior Designers

Roan G. Gomez, Ala Drawn By: SANTA ROSA - PHASE .
Sheet:

COVER

CIVIL ENGINEERS

(956) 548-9333 FAX (956) 548-9399

AMBIOTEC GROUP INC. 5420 PAREDES LINE RD., BROWNSVILLE, TEXAS 78526 LANDSCAPE

SSP LANDSCAPE DESIGN

802 EAST WASHINGTON BROWNSVILLE, TEXAS 78520 (956) 547-9788 FAX: (956) 547-9977

ARCHITECTS

1220 W. HARRISON HARLINGEN, TX 78550

119 VAN BUREN, SUITE 101 HARLINGEN, TEXAS 78550


CONCESSION DEMOLITION PLAN

PLUMBING SCHEDULE; DETAILS

CONCESSION PLUMBING PLAN

# CONSTRUCTION PLANS FOR

# PARK PARKING LOT IMPROVEMENTS SANTA ROSA, TEXAS

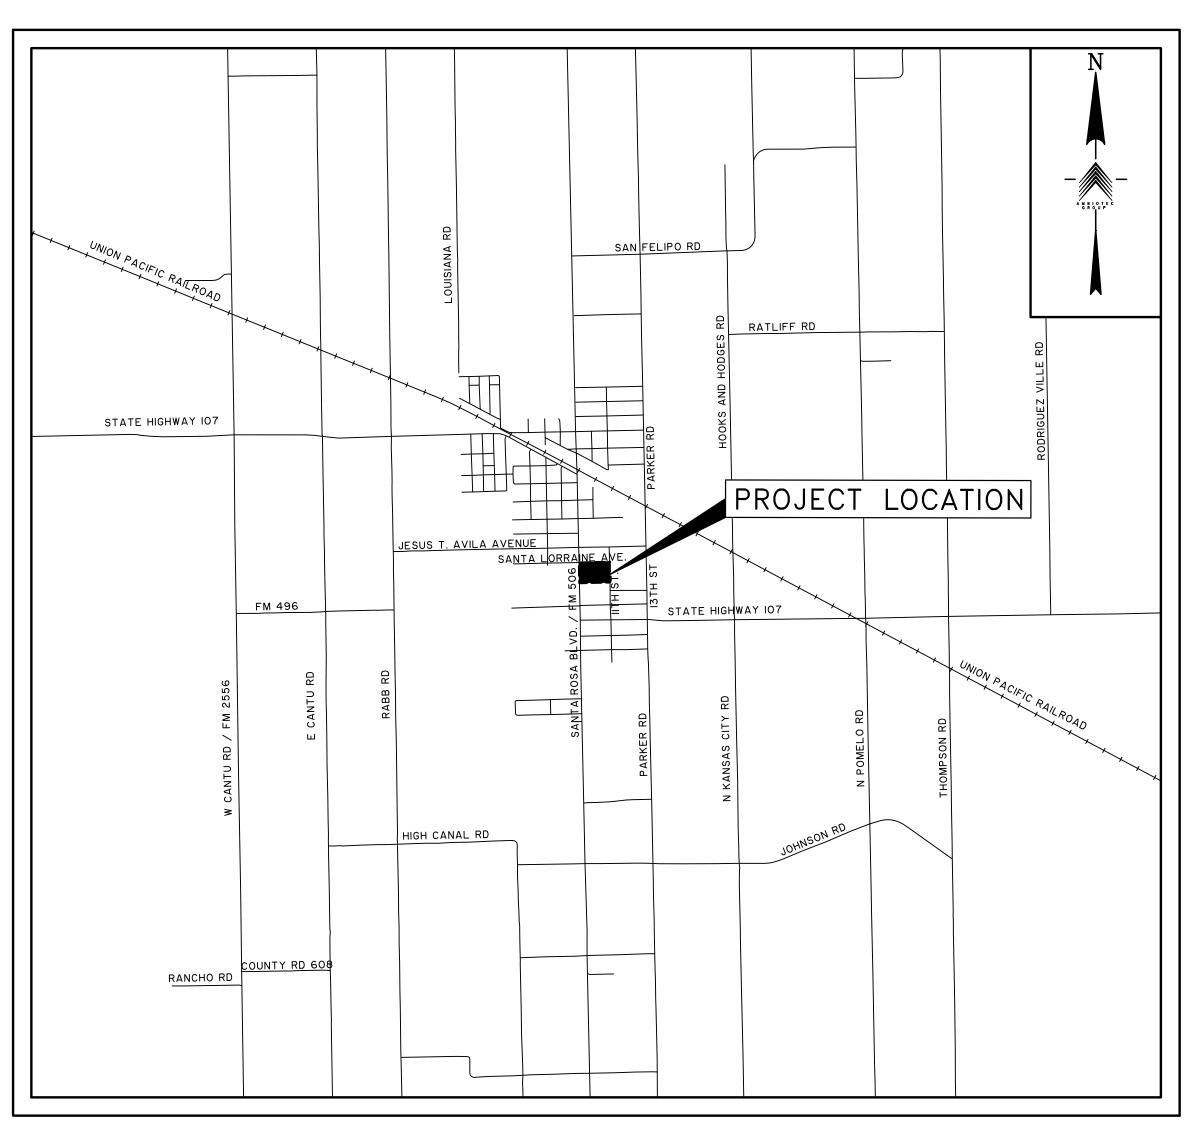

VICINITY MAP

SCALE: I"=2000'

DECEMBER 2022 PREPARED BY AMBIOTEC CIVIL ENGINEERING GROUP, INC.

# TABLE OF CONTENTS

COVER SHEET

GENERAL NOTES

EXISTING SITE/DEMOLITION PLAN

MINIMUM SUGGESTED EROSION CONTROL MEASURE

MINIMUM SUGGESTES EROSION CONTROL DETAILS

6 DIMENSION PLAN

7 GRADING PLAN

DETAILS

AMBIOTEC


CIVIL ENGINEERING GROUP, INC.

5420 Paredes Line Road Fax (956)548-93

Brownsville, Texas 78526 (956)548-93

TBPE FIRM No. F-4126

TBPIS DEC NO. 10005200

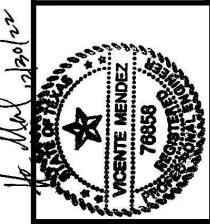

ARK PARKING LOT IMPROVEMENT

OVER SHEFT

Y: K. SALDIVAR Y:E. LUNA BY: K. SALDIVAR ED BY: V. MENDEZ

DE SIG DRAV CHEC

4

F 08

#### GENERAL NOTES

- \* PRIOR TO BEGINNING CONSTRUCTION, THE OWNER OR HIS AUTHORIZED REPRESENTATIVE SHALL SCHEDULE A PRECONSTRUCTION CONFERENCE BETWEEN THE OWNER & THE CONSULTING ENGINEER, CONTRACTOR, BPUB AND ALL OTHER AFFECTED PARTIES.
- \* CONTRACTOR TO KEEP ACCESS PUBLIC ROADS OPEN AT ALL TIMES FOR EMPLOYEES. AREA USED FOR CONTRACTOR'S PERSONNEL PARKING, MATERIAL STORAGE, STOCKPILE, MATERIAL FABRICATION, AND RELATED CONSTRUCTION USES ARE NOT TO INTERFERE WITH NORMAL TRAFFIC.
- \* CONTRACTOR TO GIVE NOTICE IN WRITING TO ALL AUTHORIZED INSPECTORS, SUPERINTENDENTS, OR PERSONS IN CHARGE OF PRIVATE AND PUBLIC UTILITIES AFFECTED BY HIS OPERATIONS PRIOR TO COMMENCEMENT OF WORK.
- \* CONTRACTOR SHALL PERSONALLY ENSURE THAT ALL CONSTRUCTION PERMITS HAVE BEEN OBTAINED PRIOR TO COMMENCEMENT OF WORK. REQUIRED PERMITS THAT CAN BE ISSUED ONLY TO CONTRACTOR SHALL BE OBTAINED AT NO EXPENSE TO THE OWNER.
- \* UTILITY NOTE: THE LOCATIONS OF ALL EXISTING UTILITIES SHOWN ON THESE PLANS ARE BASED UPON RECORD INFORMATION ONLY, AND HAVE NOT BEEN INDEPENDENTLY VERIFIED BY THE OWNER OR THE ENGINEER. THE CONTRACTOR SHALL DETERMINE THE EXACT LOCATION, HORIZONTAL AND VERTICAL OF ALL EXISTING UTILITIES BEFORE COMMENCING WORK, AND AGREES TO BE FULLY RESPONSIBLE FOR ANY AND ALL DAMAGES WHICH MIGHT BE CAUSED BY THE CONTRACTOR'S FAILURE TO EXACTLY LOCATE AND PRESERVE ANY AND ALL UNDERGROUND UTILITIES, EXISTING OR ABANDONED. NO SEPARATE PAY. THE INFORMATION SHOWN CONCERNING TYPE AND LOCATIONS OF UNDERGROUND AND OVERHEAD UTILITIES IS NOT GUARANTEED TO BE ACCURATE OR ALL INCLUSIVE. CONTRACTOR SHALL BE RESPONSIBLE FOR VERIFICATION OF EXISTING UTILITIES. THE CONTRACTORS INFORMATION SHALL BE CONDUCTED TO PREVENT UNNECESSARY INTERFERENCE WITH ANY EXISTING UTILITY SYSTEM INFRASTRUCTURE. IF THE CONTRACTOR'S WORK REQUIRES INTERRUPTION, THE CONTRACTOR MUST COORDINATE WITH AFFECTED UTILITY COMPANIES 48 HOURS IN ADVANCE.
- \* THROUGHOUT THE CONSTRUCTION, AND AT THE COMPLETION OF CONSTRUCTION, THE CONTRACTOR IS TO ENSURE THAT DRAINAGE OF STORM WATER RUNOFF IS NOT BLOCKED. MAINTAIN DRAINAGE OF SITE DURING ALL PHASES OF CONSTRUCTION. DO NOT BLOCK DRAINAGE FROM ADJACENT AREAS NOR ADD FLOW TO ADJACENT AREAS.
- \* THE CONTRACTOR SHALL NOTIFY ALL UTILITY COMPANIES 48 HOURS PRIOR TO BEGINNING OF CONSTRUCTION IN A PARTICULAR AREA.
- \* DAMAGES DONE TO EXISTING UTILITIES, POWER POLES, FENCES, SIGNS, MAILBOXES, DRIVEWAYS, CULVERTS, PAVEMENT, DRAINAGE SYSTEMS, ETC., SHALL BE REPAIRED BY THE CONTRACTOR AT NO COST TO THE OWNER. DRIVEWAYS SHALL BE REPAIRED ON A LIKE FOR LIKE BASIS.
- \* THE CONTRACTOR SHALL HAVE A PERSON ON CALL 24 HOURS A DAY TO TAKE CARE OF MAINTENANCE ITEMS-CONSTRUCTION AREA, SIGNS ETC. THIS PERSON SHALL HAVE AUTHORITY TO ACT ON BEHALF OF THE CONTRACTOR IN EMERGENCY CONDITIONS. THE PERSON SHALL BE STATIONED CLOSE ENOUGH TO BE ON SITE WITHIN I/2 HOUR OF NOTIFICATION. THE PERSON SHALL BE IDENTIFIED IN WRITING PRIOR TO THE START OF CONSTRUCTION. THE ON-SITE REPRESENTATIVE SHALL HAVE ACCESS TO ALL EQUIPMENT AND MATERIAL AND HAVE FULL AUTHORITY NECESSARY TO CORRECT ANY PROBLEMS. DEFICIENCIES, OR EMERGENCIES WHICH MAY ARISE. DURING NON-WORKING HOURS, AND DURING THE ABSENCE OF THE SUPERINTENDENT.
- \* EXCESS SPOIL PRODUCED DURING PREPARATION OF THE SUB-GRADE SHALL BE PLACED SPREAD AND COMPACTED ON-SITE IN AREAS AS INSTRUCTED BY THE ENGINEER TO ACHIEVE ADEQUATE GRADING. ANY UNUSABLE MATERIAL WILL BECOME THE PROPERTY OF THE CONTRACTOR TO BE PROPERLY DISPOSED OF AT HIS EXPENSE OR TO HIS ADVANTAGE.
- \* THE CONTRACTOR WILL PROVIDE HIS OWN CONSTRUCTION STAKING.
- \* CONTRACTOR TO MATCH EXISTING PAVEMENT, SIDEWALK RAMPS AND CURB & GUTTER PAVEMENT OR ANY OTHER IMPROVEMENTS WHERE APPLICABLE.
- \* ALL CONCRETE AND ASPHALT DRIVEWAYS ADJUSTED, DAMAGED, OR REPLACED DURING CONSTRUCTION MUST BE SAW-CUT AT A STRAIGHT, NEAT LINE, BEFORE REPAIRING.
- \* ABANDONED LINES FOUND DURING CONSTRUCTION SHALL BE REMOVED (UNLESS SPECIFIED OTHERWISE). NO SEPARATE PAY. THIS WORK SHALL BE SUBSIDIARY TO OTHER WORK.
- \* THE CONTRACTOR SHALL PLACE BARRICADES, FLAG-MEN, ETC. ON THIS PROJECT IN COMPLIANCE WITH THE PROCEDURE OUTLINED IN THE "TEXAS MANUAL ON UNIFORM TRAFFIC CONTROL DEVICES FOR STREET AND HIGHWAYS." (PART IV TRAFFIC CONTROLS FOR STREET AND HIGHWAY CONSTRUCTION AND MAINTENANCE OPERATIONS, LATEST REVISION). UPON COMPLETION OF THE WORK, ALL SIGNS SHALL BE REMOVED BY THE CONTRACTOR.
- \* REFERENCE POINTS: THE ENGINEER WILL ESTABLISH HORIZONTAL AND VERTICAL CONTROLS ONLY (REFERENCE POINTS AND BENCHMARKS AS SHOWN ON THE CONSTRUCTION PLANS.) THE CONTRACTOR MUST NOTIFY THE ENGINEER AT LEAST 48 HOURS PRIOR TO STARTING WORK ON ANY SECTION OR PART OF THE WORK WHERE CONTROLS HAVE NOT BEEN ESTABLISHED OR ARE NOT IDENTIFIABLE OR VISIBLE TO THE CONTRACTOR. THE ENGINEER WILL UPON SUCH ADVANCE NOTICE WILL REPLACE ANY CONTROL POINTS THAT HAVE BEEN DESTROYED BY OTHERS PRIOR TO BEGINNING OF CONTRACTORS OPERATIONS. AFTER CONTROL POINTS ARE ESTABLISHED AND / OR IDENTIFIED AS OUTLINED ABOVE, MAINTENANCE OF SUCH CONTROL POINTS SHALL BE RESPONSIBILITY OF THE CONTRACTOR. ANY RE-STAKING REQUIRED FOR ANY REASON THEREAFTER SHALL BE THE RESPONSIBILITY OF THE CONTRACTOR. THE CONTRACTOR WILL PROVIDE ALL OTHER CONSTRUCTION STAKING (CUT STAKES, BLUE TOPPING, INTERMEDIATE STRING LINE CONTROL, ETC.) REQUIRED TO VERIFY GRADES, DEPTHS THICKNESSES, AND ALIGNMENT OF THE VARIOUS ITEMS OF CONSTRUCTION.
- \* AS BUILT DRAWINGS: THE CONTRACTOR IS RESPONSIBLE FOR MAINTAINING A SET OF AS-BUILT PLANS SHOWING NOTES TO ANY CHANGES TO THE DESIGN PLANS. THIS INFORMATION, SIGNED BY ALL INSPECTORS, WILL BE SUBMITTED TO THE ENGINEER AT THE END OF CONSTRUCTION. THE PROJECT'S FINAL ACCEPTANCE AND FINAL PAYMENT WILL NOT BE APPROVED UNTIL THE CONTRACTOR HAS SUBMITTED THE REQUIRED INFORMATION NEEDED BY THE ENGINEER FOR AS-BUILT DRAWINGS.
- \* CONCRETE CURB AND GUTTER, PIPE STRUCTURES, ETC. WHICH MUST BE REMOVED IN ORDER TO CONSTRUCT THE PROPOSED IMPROVEMENTS WILL BECOME THE PROPERTY OF THE CONTRACTOR AND SHALL BE REMOVED AND PROPERLY DISPOSED OF AT THE CONTRACTOR'S EXPENSE. THIS WORK SHALL BE CONSIDERED SUBSIDIARY TO THE VARIOUS BID ITEMS IN THE CONTRACT.
- \* MATERIALS CERTIFICATION AND TESTING: CONTRACTOR SHALL PROVIDE SUPPLIERS CERTIFICATION FOR ALL PROJECT MATERIALS (CONCRETE, HYDRATED LIME, LIME-STONE BASE MATERIAL, PRE-CAST INLETS, PIPES, ETC.) THAT SUCH MATERIALS DO MEET PROJECT SPECIFICATIONS PRIOR TO DELIVERY ON-SITE. CONTRACTOR SHALL PROVIDE HOT MIX ASPHALTIC CONCRETE DESIGN FROM A REPUTABLE COMMERCIAL TESTING LABORATORY.

\* STANDARD WORK HOURS: THE STANDARD WORK HOURS FOR THE OWNER IS 8:00 AM TO 5:00 PM, MONDAY THROUGH FRIDAY. SHOULD THE CONTRACTOR ELECT TO WORK ON SATURDAY, SUNDAYS OR HOLIDAYS, THE CONTRACTOR SHALL BE RESPONSIBLE FOR PAYING OVERTIME CHARGES FOR THE OWNER'S PERSONNEL INVOLVED. THESE CHARGES WILL BE AT COST AND WILL BE CALCULATED EITHER AT TIME AND A HALF OR DOUBLE TIME, AS APPLICABLE TO THE PARTICULAR DAY BEING WORKED. PRE-APPROVAL SHALL BE OBTAINED FROM THE ENGINEER OR ENGINEER'S REPRESENTATIVE BY COMPLETING AND SIGNING A OWNER'S FORM ENTITLED "CONSTRUCTION INSPECTORS OVERTIME COMPENSATION AUTHORIZATION", 48 HRS. PRIOR TO COMMENCING ANY OVERTIME WORK. ANY WORK DONE OUTSIDE THE STANDARD WORKDAY, WITHOUT PRIOR AUTHORIZATION, SHALL BE CONSIDERED UNAUTHORIZED WORK. THE CONTRACTOR IS REQUIRED TO PAY THE OVERTIME WAGES OF THE OWNER INSPECTORS THAT WORK OVERTIME MONDAYS THROUGH FRIDAYS AT TIME AND A HALF. THE CONTRACTOR IS RESPONSIBLE FOR THE OVERTIME WAGES OF THE OWNER INSPECTORS THAT WORK HOLIDAYS AT DOUBLE TIME MINIMUM HOURS WILL BE BILLED TO CONTRACTOR FOR CALLOUTS OR FOR INSUFFICIENT NOTICE OF TWO (2) HOURS.

#### CONCRETE MIX DESIGN

- \* CLARIFICATION: ALL CONCRETE USED ON THIS PROJECT SHALL CONTAIN A MINIMUM 4.5 SACKS OF CEMENTITIOUS MATERIAL PER CUBIC YARD OF CONCRETE. THE CEMENTITIOUS MATERIAL SHALL BE PORTLAND CEMENT OR A BLEND OF PORTLAND CEMENT AND FLY ASH. THE PERCENTAGE OF FLY ASH IN THE CEMENTITIOUS MATERIAL SHALL NOT EXCEED 23%. ALL CONCRETE WORK SHALL CONTAIN I.5 POUNDS OF FIBER MESH PER CUBIC YARD.
- \* ALL EXPOSED CONCRETE SURFACES SHALL BE TREATED WITH CURING COMPOUND RESIN BASE ASTM C 309 TYPE 2 WITH PIGMENTED TINT OF FUGITIVE DYE.
- \* IN ADDITION TO THE ABOVE REQUIREMENTS, ALL CONCRETE SHALL TEST TO A MINIMUM 3000 PSI COMPRESSIVE STRENGTH AT 28 DAYS. (OR AS SHOWN ON PLANS).
- \* EXPANSION JOINTS WILL BE PLACED AT CURB RETURNS, INLETS AND AT THE END OF EACH POUR WITH INTERVALS NOT TO EXCEED 60 FT. JOINTS SHALL CONSIST OF I/2" PRE-MOLDED EXPANSION JOINT MATERIAL WITH 3, 36" X I/2" DOWELS, ONE END GREASED AND WRAPPED. CARE MUST BE TAKEN THAT DOWELS ARE STRAIGHT AND LAID PARALLEL WITH CURB AND NO CONCRETE PLUGS OR OTHER MATERIAL BE ALLOWED THROUGH THE DOWEL HOLES OR EXPANSION MATERIAL WHICH WOULD PREVENT THE JOINT FROM OPERATION AS AN EXPANSION JOINT. EXPANSION JOINT MATERIALS SHALL BE PRE-MOLDED ASPHALT IMPREGNATED EXPANSION JOINT MATERIAL CONFORMING WITH ASTM D 994 ( NOT WOOD FIBER TYPE )
- \* DUMMY JOINTS (SAW CUT JOINTS) SHALL BE 2" DEEP AND PLACED AT MAXIMUM 15 FT. INTERVALS.
- \* WHEN CONNECTING TO EXISTING CURB AND GUTTER, THE CONTRACTOR SHALL DRILL AND DOWEL TWO, # 6 X 16" TIE BARS A MINIMUM OF 6" DEEP INTO EXISTING CURB AND GUTTER SECTION.

#### PAVING NOTES:

#### CRUSHED LIMESTONE:

THE CRUSHED LIMESTONE MATERIALS SHALL BE AS SPECIFIED BY "ITEM 247 FLEXIBLE BASE TYPE A GRADE I." TEXAS DEPARTMENT OF TRANSPORTATION, 2014 STANDARD SPECIFICATION FOR CONSTRUCTION OF HIGHWAYS, STREETS, AND BRIDGES SHALL MEET THE REQUIREMENTS AS FOLLOWS:

- \* TYPE A MATERIAL SHALL BE CRUSHED STONE PRODUCED FROM OVERSIZE QUARRIED AGGREGATE, SIZED BY CRUSHING AND PRODUCED FROM A NATURALLY OCCURRING SINGLE SOURCE. CRUSHED GRAVEL OR UNCRUSHED GRAVEL SHALL NOT BE ACCEPTABLE FOR TYPE A MATERIAL. NO BLENDING OF SOURCES AND/OR ADDITIVE MATERIALS WILL BE ALLOWED IN TYPE A MATERIAL.
- \* TRIAXIAL CLASS I: MINIMUM COMPRESSIVE STRENGTH, 45 AT OPSI LATERAL PRESSURE AND 175 AT 15 PSI LATERAL PRESSURE.

RETAINED ON SQUARE SIEVE NUMBER	PERCENT RETAINED
I-3/4" (44 MM)	0
7/8" (22.23 MM)	10-35
3/8" (9.5 MM)	30-50
NUMBER 4 (4.75 MM)	45-65

70-85

MATERIAL PASSING THE NUMBER 40 SIEVE SHALL BE KNOWN AS "BINDER MATERIAL" AND SHALL MEET THE FOLLOWING REQUIREMENTS:

MAXIMUM LIQUID LIMIT ( LL ) = 35
MAXIMUM PLASTICITY INDEX ( PI ) = 10
WET BALL MILL (MAX) = 40

CALIFORNIA BEARING RATIO (MIN) = 100

NUMBER 40 (0.425 MM)

ALL AGGREGATE RETAINED ON THE NUMBER 10 SIEVE SHALL BE COMPRISED OF ONLY CRUSHED LIMESTONE.

THE CONTRACTOR SHALL NOT PLACE CRUSHED LIMESTONE ON THE ROAD BED UNTIL THE ENGINEER HAS ACCEPTED THE SHAPED AND COMPACTED SUBGRADE.

THE CONTRACTOR MUST MAINTAIN THE ROAD BED FREE OF HOLES, RUTS AND DEPRESSIONS AND IN CONDITION TO RECEIVE THE CRUSHED LIMESTONE.

THE CONTRACTOR UPON REQUEST SHALL PROVIDE CERTIFICATION THAT THE MATERIAL SUPPLIED MEETS THE ABOVE REQUIREMENTS PRIOR TO DELIVERY TO THE JOB SITE. SAMPLES FOR TESTING OF THE MATERIAL MUST BE TAKEN PRIOR TO THE COMPACTION OPERATIONS.

### CRUSHED LIMESTONE: GRADE 3

IF TYPE A, GRADE I CRUSHED LIMESTONE IS NOT AVAILABLE, CONTRACTOR MAY USE TXDOT 2014 SPECIFICATION ITEM 247, GRADE 3 FLEXIBLE BASE MATERIALS. (ALANZA BASE BY VULCAN OR APPROVED EQUAL)

#### ACCEPTANCE, SAMPLING, AND TESTING OF BITUMINOUS MIXTURE ( COMPACTION )

- \* EXTRACTION AND GRADATION ANALYSIS: PER 500 TONS OR WHICHEVER IS GREATER.
- \* DENSITY AND DEPTH TESTING: PER 500 FEET OF PAVING REPAIR.
  MINIMUM DENSITY ACCEPTED: 92% OF AVERAGE MAXIMUM THEORETICAL DENSITY AS
  DETERMINED IN ACCORDANCE WITH ASTM D 2041.
- CORES OR SAWED SAMPLES TAKEN FROM THE PAVEMENT SHALL BE USED TO DETERMINE THE FIELD DENSITY. DENSITY OF THE CORED OR SAWED SAMPLES SHALL BE DETERMINED IN ACCORDANCE WITH ASTM 2725. THE SAME SPECIMEN SHALL BE USED FOR DETERMINING BOTH THE MAXIMUM THEORETICAL DENSITY AND THE FIELD DENSITY.
- SPECIMENS TO BE USED FOR FIELD DENSITY DETERMINATION SHALL BE DONE USING HEAT. IF HEATING IS NECESSARY, THE SPECIMEN SHOULD BE HEATED TO THE LOWEST TEMPERATURE REQUIRED FOR PROPER PREPARATION OF THE SAMPLE; THE USE OF NUCLEAR FIELD DENSITY DETERMINATION SHALL NOT BE USED AS A BASIS FOR ACCEPTANCE WITH RESPECT TO DENSITY:
- \* HVEEM STABILITY SHALL NOT BE LESS THAN 30%. STABILITY TEST SHALL BE TAKEN TWICE DAILY.
- \* RETAINED STABILITY WHEN TESTED IN ACCORDANCE WITH ASTM D 1075 SHALL NOT BE <70%
- \* NO MORE THAN 2½" FINISHED THICKNESS HMAC PAVEMENT SHALL BE LAID AT ANY GIVEN TIME. UNLESS APPROVAL IS OBTAINED AHEAD BY THE OWNER / ENGINEER.

# LEGEND

	EXISTING
P	POST
©	CLEANOUT
\$	LIGHTPOLE
PP.	DISTRIBUTION POWERPOLE
***************************************	PALM TREE
**************************************	TREE
***	WATER VALVE
$\otimes$	IRRIGATION CONTROL VALVE
0 0	WATER BIB
V	FIRE HYDRANT
\$	SPRINKLER
M	MANHOLE
M	MAILBOX
-0	SIGN
T	TELEPHONE PEDESTAL
E	ELECTRIC BOX
EM	ELECTRIC METER
<b></b>	FLOOD LAMP
N	ELECTRICAL TRANSFORMER
[C]	CABLE TV PEDESTAL
 UTL	UNDERGROUND TELEPHONE LINE
— UE —	UNDERGROUND ELECTRIC LINE
— OE —	OVERHEAD ELECTRIC DISTRIBUTION LINE
	BANK LINE
ВА	BANK LINE DESCRIPTION WITH ELEVATION
BU	BUILDING DESCRIPTION WITH ELEVATION
СС	CONCRETE DESCRIPTION WITH ELEVATION
FL	FLOW LINE DESCRIPTION WITH ELEVATION
FF	FINISH FLOOR DESCRIPTION WITH ELEVATION
GUT	GUTTER DESCRIPTION WITH ELEVATION
PLR	PLANTER DESCRIPTION WITH ELEVATION
RCP	REINFORCED CONCRETE PIPE
SE	SPOT ELEVATION
WK	SIDEWALK DESCRIPTION WITH ELEVATION
14	CONCRETE
4 <del>.</del>	ASPHALT
	DIRT ROAD
+0.00	ELEVATION

PROPOSED					
<u></u>	BANK LINE				
0.0%	GRADE TO DRAIN SLOPE				
	SWALE WITH DIRECTION				
	HATCH FOR REMOVAL ITEMS				
	2" HMAC PAVEMENT				
TW=32.22	PROP. TOP OF SIDEWALK				
TC=32.22	PROP. TOP OF CURB				
(FL=32.22)	PROP. FLOW LINE				
(FG=32.22)	PROP. FINISH GRADE				
TP=32.22	PROP. TOP OF PAVEMENT				
F.F.=27.30	FINISH FLOOR ELEVATION				
EXIST.	EXISTING				
CONC.	CONCRETE				
TYP.	TYPICAL				
PROP.	PROPOSED				
TEMP.	TEMPORARY				
O.C.	ON CENTER				
O.C.E.W.	ON CENTER EACH WAY				
C-C	CENTER TO CENTER				
R.O.W.	RIGHT-OF-WAY				
C.F.	CUBIC FEET				
C.Y.	CUBIC YARDS				
MIN.	MINIMUM				
MAX.	MAXIMUM				
INCL.	INCLUDING				
LF	LINEAR FEET				
EL	ELEVATION				
MEP	MECHANICAL, ELECTRICAL & PLUMBING				
НМАС	HOT MIX ASPHALT CONCRETE				
W/	WITH				
F.H.	FIRE HYDRANT				
P.S.I.	POUNDS PER SQUARE INCH				
A.D.A.	AMERICANS WITH DISABILITIES ACT				



CIVIL ENGINEERING GROUP,
Paredes Line Road Fax (95)





KING LOT IMPROVEMENTS
D FOR: CITY OF SANTA ROSA


ENERAL NOTES


SALDIVAR UNA . SALDIVAR V. MENDEZ

DESIGN BY: K. SA
DRAWN BY: E. LUN
CHECKED BY: K. S

SHEET

OF 08

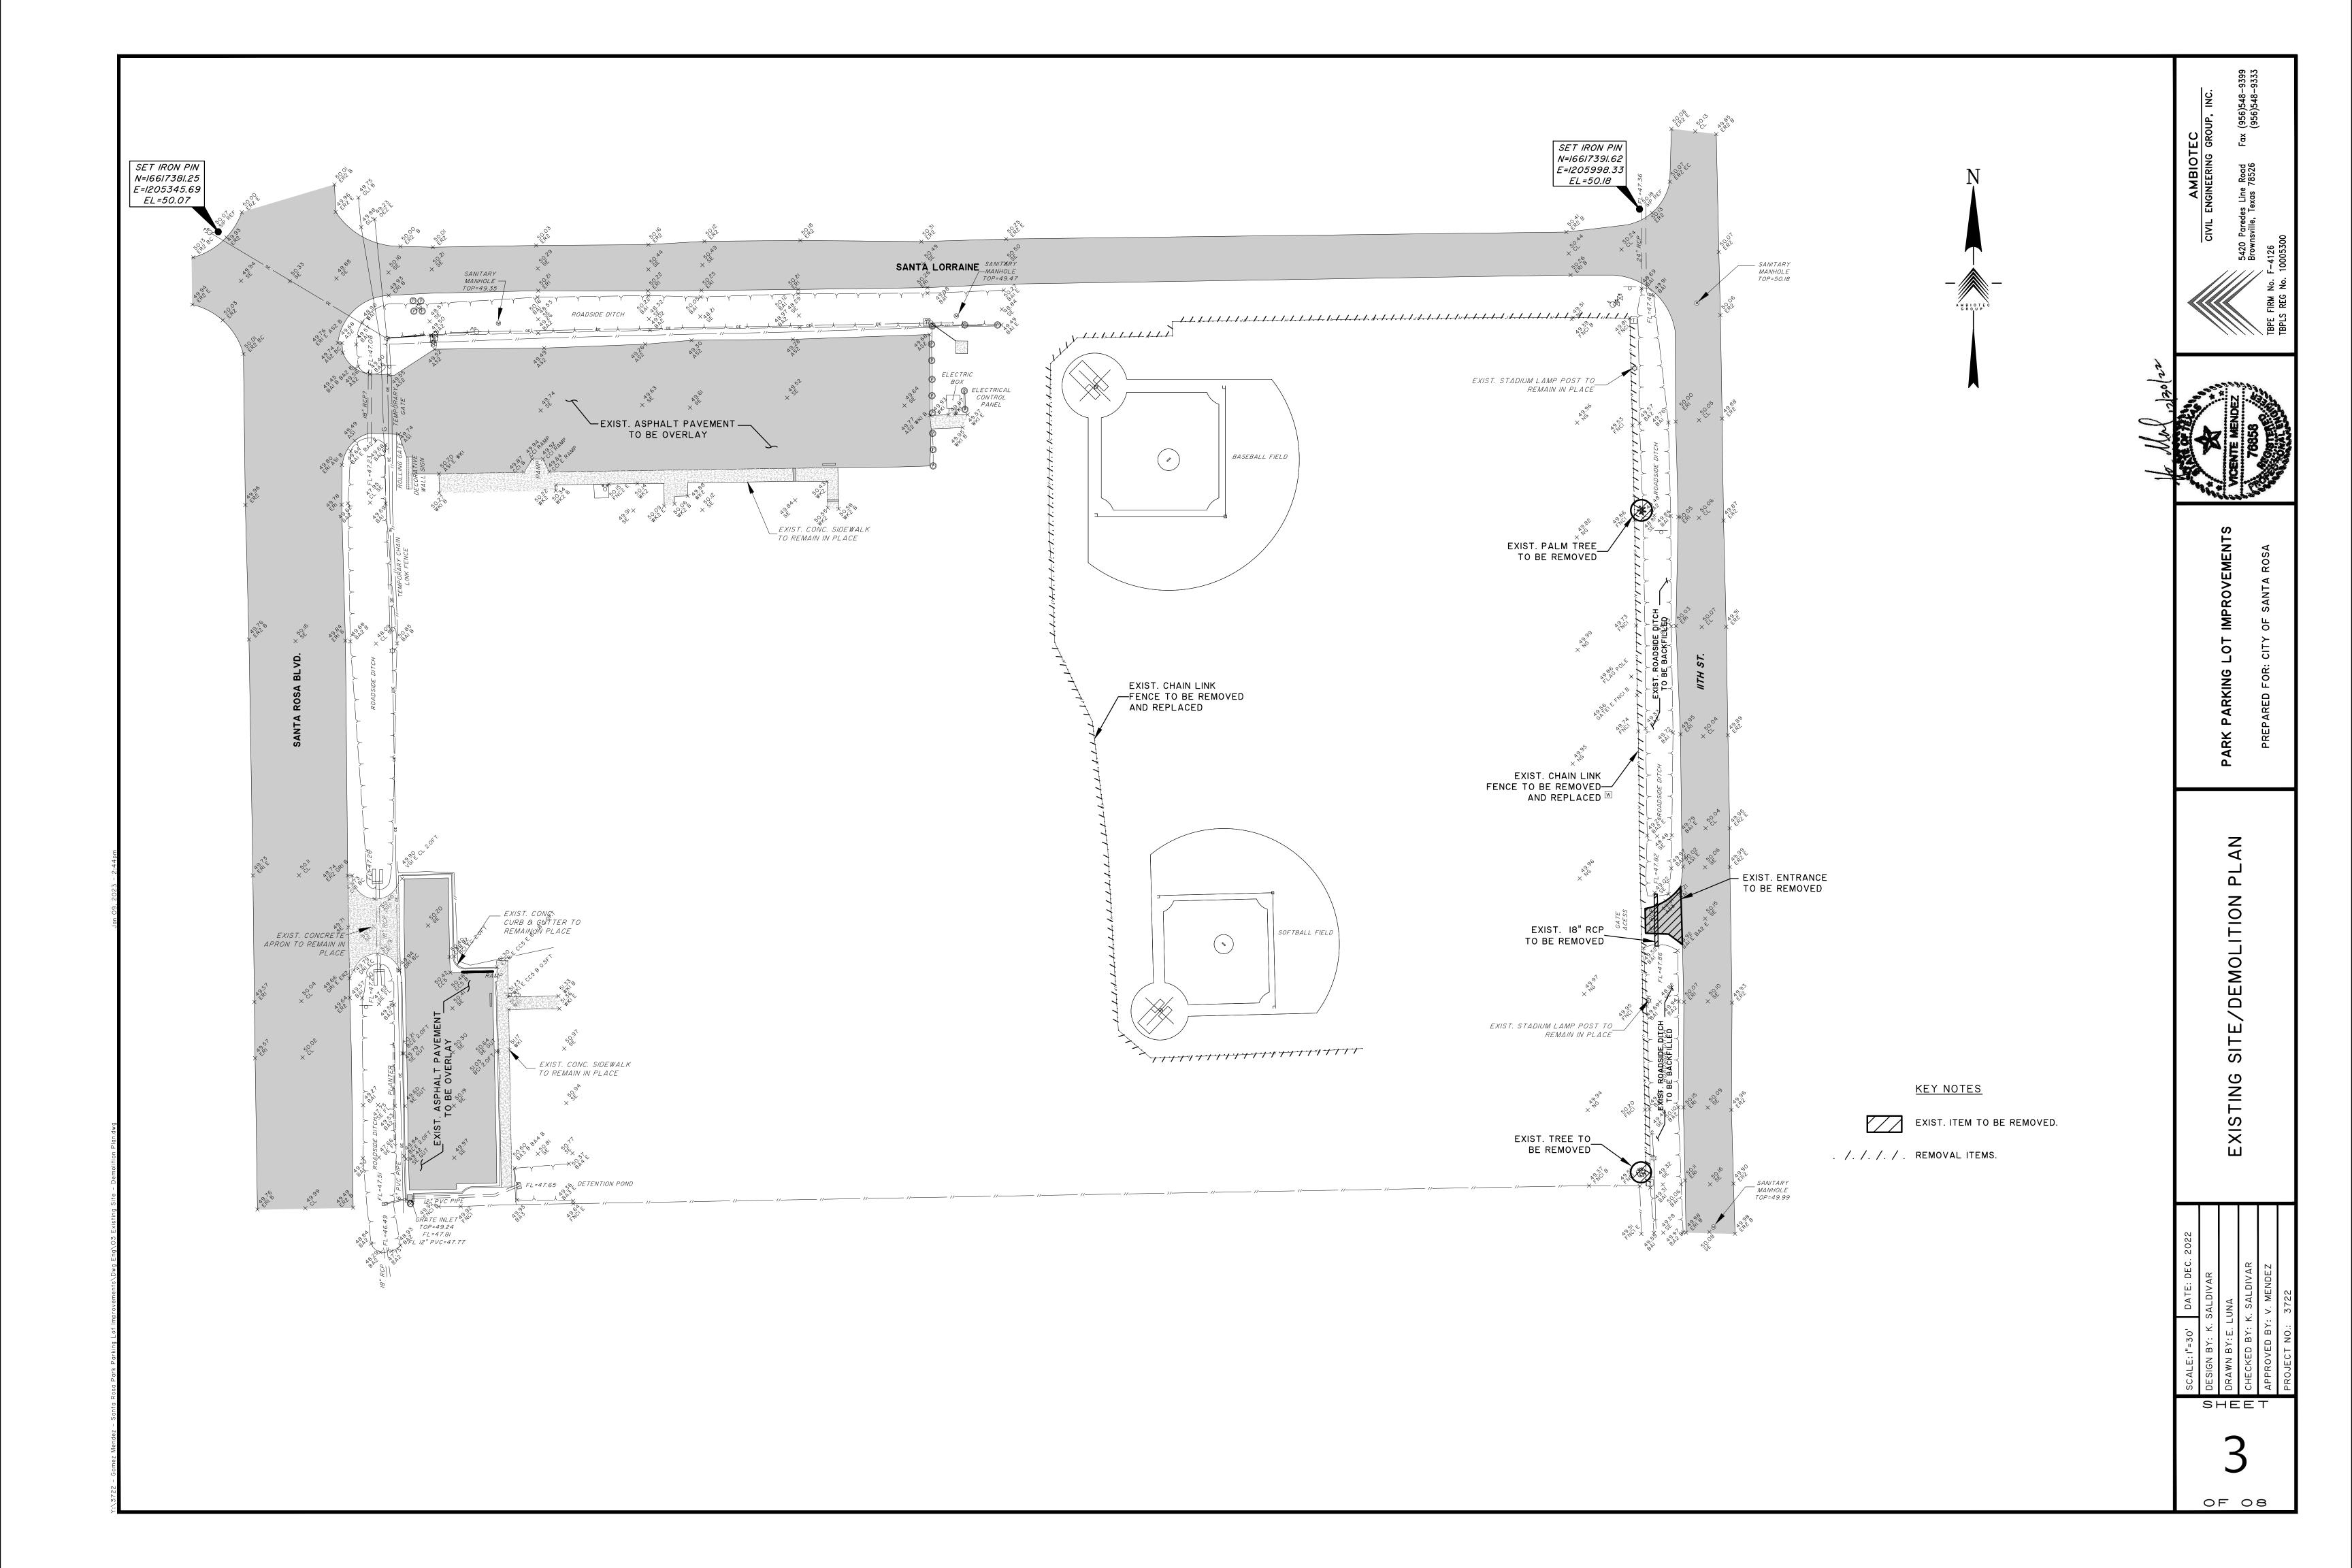

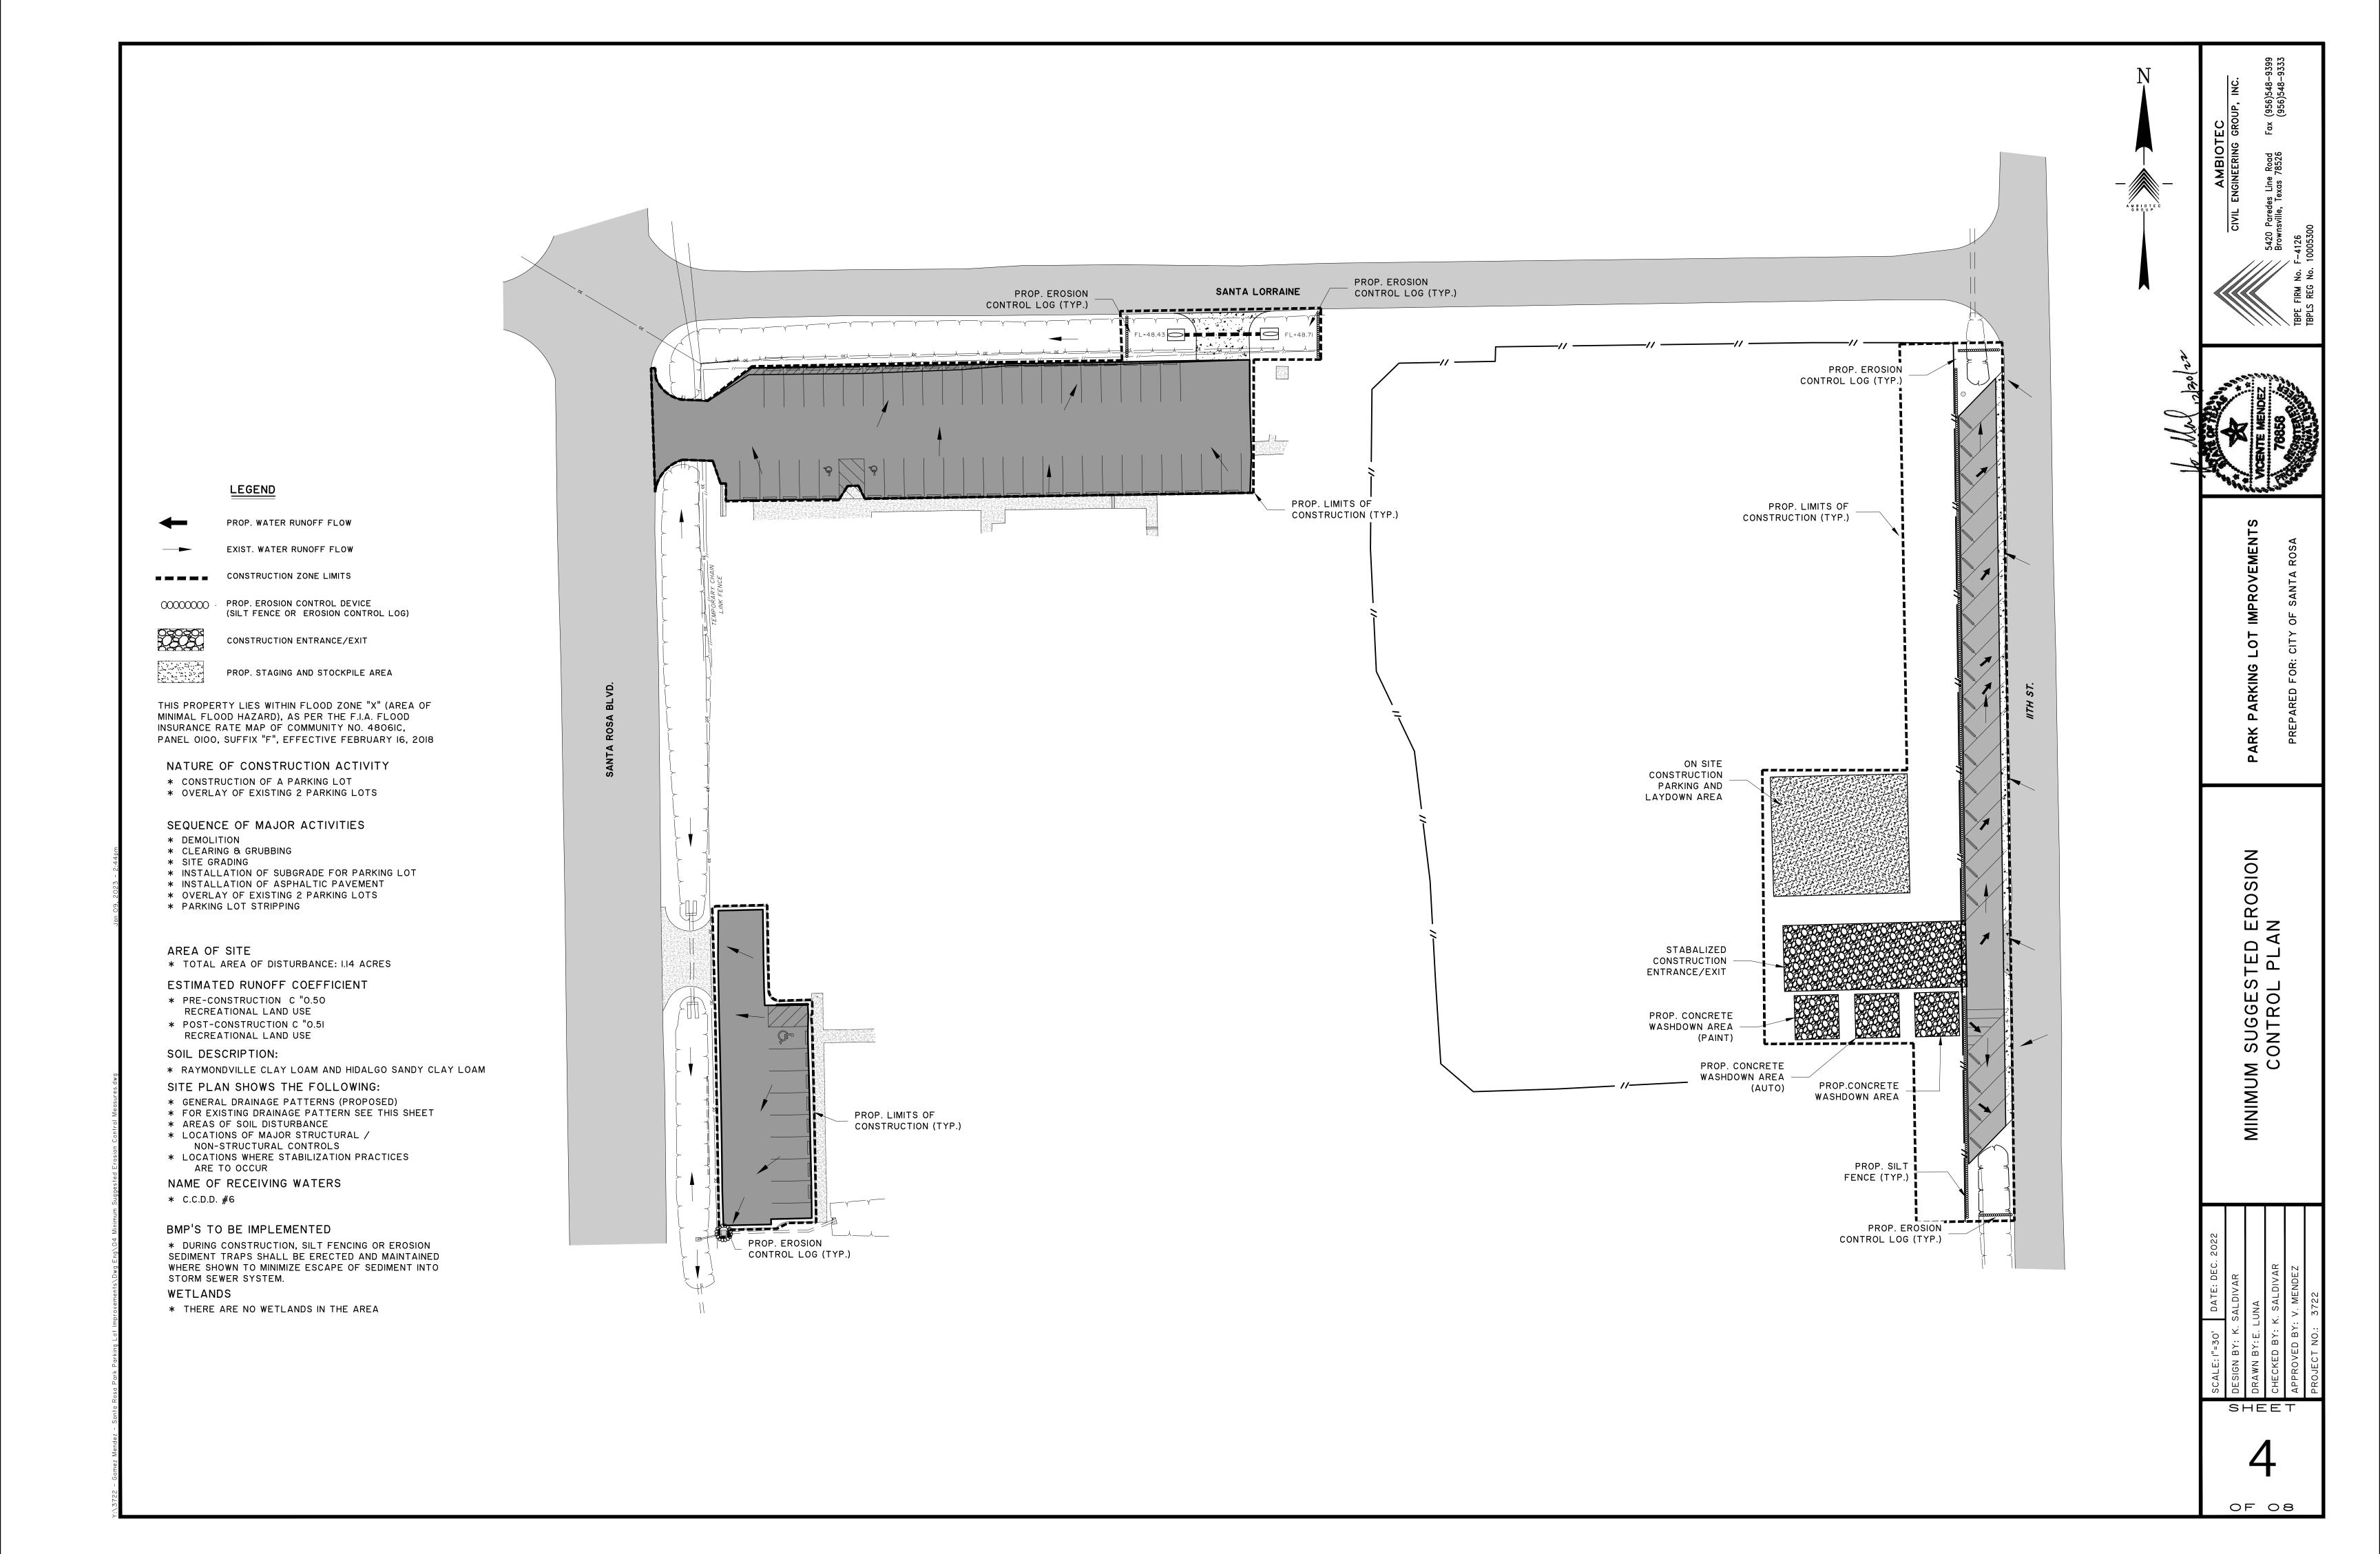

NON-WOVEN
GEOTEXTILE FABRIC (18" TO 36" HIGH) WOVEN WIRE SUPPORT BACKFILL TRENCH WITH COMPACTED SOIL -STEEL FENCE POST

SILT FENCE DETAIL

DITCH LINE SEDIMENT TRAP A-A

DITCH LINE SEDIMENT TRAP

12" TEMP. EROSION CONTROL SOCK


-PENETRATE TOP SOCK AS SHOWN


12" TEMP. EROSION


COMPOST CRADLE


COMPOST CRADLE 🥆 🤈 UNDER EROSION
CONTROL DEVICE

CONTROL SOCK

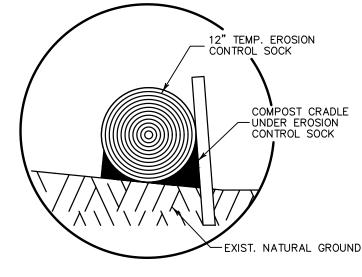


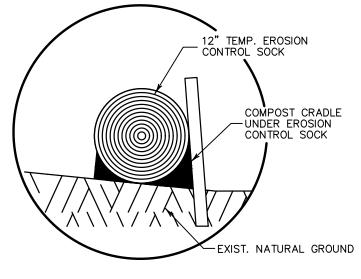


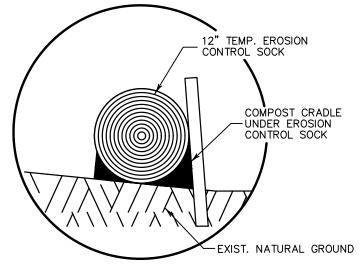

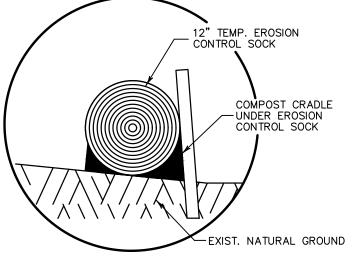



COMPOST CRADLE

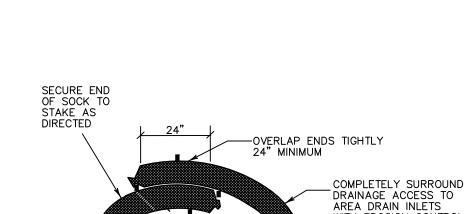

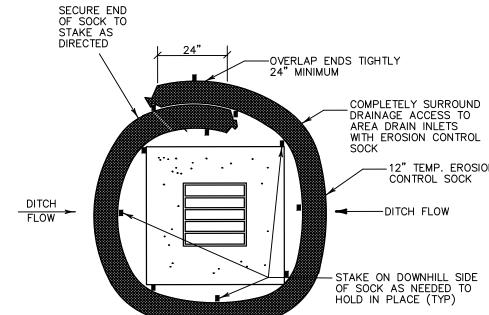



TYPE 'C' INLET SEDIMENT TRAP

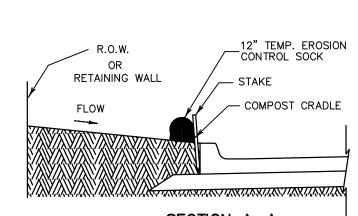

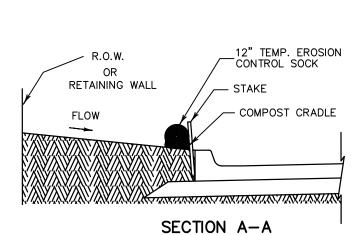

BACK OF CURB INLET SEDIMENT TRAP

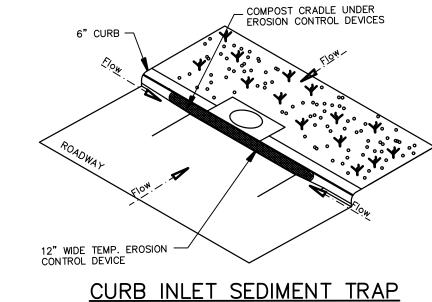

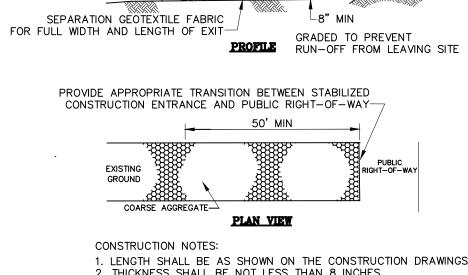

EXISTING GROUND -

FLOW

LOCATIONS:

1. LENGTH SHALL BE AS SHOWN ON THE CONSTRUCTION DRAWINGS, BUT NOT LESS THAN 50 FEET.
2. THICKNESS SHALL BE NOT LESS THAN 8 INCHES.
3. WIDTH SHALL BE NOT LESS THAN FULL WIDTH OF ALL POINTS OF INGRESS OR EGRESS.
4. STABILIZATION FOR OTHER AREAS SHALL HAVE THE SAME AGGREGATE THICKNESS AND

WIDTH REQUIREMENTS AS THE STABILIZED CONSTRUCTION EXIT, UNLESS OTHERWISE SHOWN ON THE CONSTRUCTION DRAWINGS. 5. STABILIZED AREA MAY BE WIDENED OR LENGTHENED TO ACCOMMODATE A TRUCK WASHING AREA. AN OUTLET SEDIMENT TRAP MUST BE PROVIDED FOR THE TRUCK WASHING AREA.

-----DITCH FLOW

6. STABILIZED CONSTRUCTION EXIT SHALL BE MAINTAINED FREE OF SEDIMENT FOR THE DURATION OF THE PROJECT.

# STABILIZED CONSTRUCTION EXIT

# TEMPORARY STABILIZATION

ANY AREA LEFT DISTURBED FOR MORE THAN 21 DAYS SHALL BE TEMPORARILY REVEGETATED WITH SEED AT THE DIRECTION OF THE ENGINEER.

DROP INLET SEDIMENT TRAP

SEDIMENT BASIN &

TRAP USAGE GUIDELINES

A SEDIMENT TRAP MAY BE USED TO PRECIPITATE SEDIMENT OUT OF RUNOFF DRAINING FROM AN UNSTABILIZED AREA.


SEDIMENT TRAPS SHOULD BE PLACED IN THE FOLLOWING

1. IMMEDIATELY PRECEDING DRAIN INLETS

TRAPS: THE DRAINAGE AREA FOR A SEDIMENT TRAP SHOULD NOT EXCEED 5 ACRES. THE TRAP CAPACITY SHOULD BE 1800 CF/ACRE (0.5" OVER THE DRAINAGE AREA).


IMMEDIATELY PRECEDING DRAIN INLETS
 JUST BEFORE THE DRAINAGE ENTERS A WATER COURSE
 JUST BEFORE THE DRAINAGE LEAVES THE RIGHT OF WAY
 JUST BEFORE THE DRAINAGE LEAVES THE CONSTRUCTION LIMITS WHERE DRAINAGE FLOWS AWAY FROM THE PROJECT

THE TRAP SHOULD BE CLEANED WHEN THE CAPACITY HAS BEEN REDUCED BY ½ OR THE SEDIMENT HAS ACCUMULATED TO A DEPTH OF 1', WHICHEVER IS LESS.
CLEANING AND REMOVAL OF ACCUMULATED SEDIMENT DEPOSITS IS INCIDENTAL AND WILL NOT BE PAID FOR SEPARATELY.

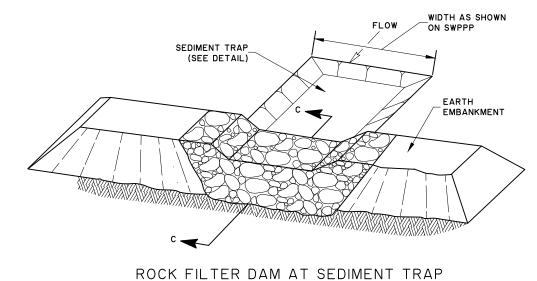

TYPICAL SEDIMENT TRAP W/ ROCK FILTER DETAIL

SEDIMENT TRAP NOTES: I. THE TRAP SHOULD BE CLEANED WHEN THE CAPACITY HAS BEEN REDUCED BY ½ OR THE SEDIMENT HAS ACCUMULATED TO A DEPTH OF I', WHICHEVER IS LESS. 2. CLEANING AND REMOVAL OF ACCUMULATED SEDIMENT DEPOSITS IS INCIDENTAL AND WILL NOT BE PAID FOR SEPARATELY.

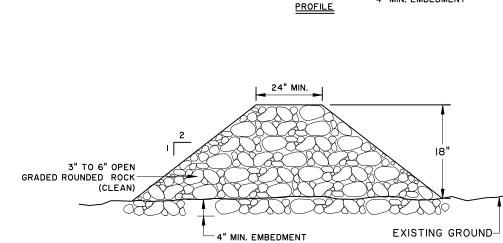


SECTION C-C


-LEVEL CRESTED WEIR


#### ROCK FILTER DAM NOTES:

EXISTING GROUND-

- I. MAINTAIN A MINIMUM OF I' BETWEEN TOP OF ROCK FILTER DAM WEIR AND TOP OF EMBANKMENT FOR FILTER DAMS AT SEDIMENT TRAPS.
- 2. FILTER DAMS SHOULD BE EMBEDDED A MINIMUM OF 4" INTO EXISTING GROUND.
- 3. FLOW OUTLET SHOULD BE ONTO A STABILIZED AREA (VEGETATION, ROCK, ETC.).

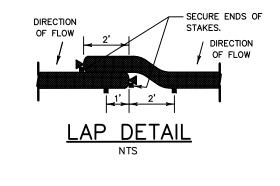


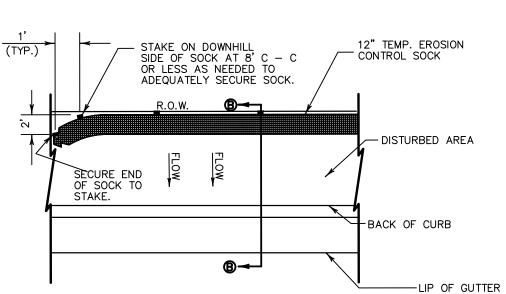

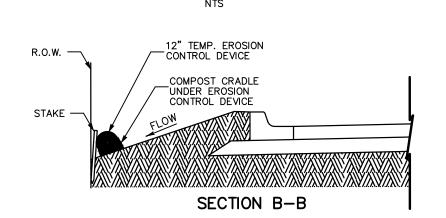


PLAN VIEW

RIGHT-OF-WAY SEDIMENT TRAP

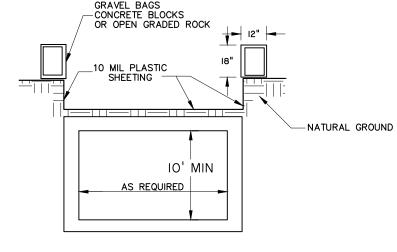

### CONCRETE WASH OUT DETAIL

- I. THE EXCAVATION FOR THE CONCRETE TRUCK WASHOUT SHALL BE A MINIMUM OF IO FEET WIDE AND OF SUFFICIENT LENGTH AND DEPTH TO ACCOMMODATE 7 GALLONS OF WASHOUT WATER AND CONCRETE PER TRUCK PER DAY AND/OR 50 GALLONS OF WASHOUT WATER AND CONCRETE PER PUMP TRUCK PER DAY.
- IN THE EVENT THAT THE CONCRETE TRUCK WASHOUT IS CONSTRUCTED ABOVE GROUND, IT SHALL BE IO FEET WIDE AND IO FEET LONG, WITH THE SAME REQUIREMENTS FOR CONTAINMENT AS DESCRIBED IN ITEM I.
- 3. THE CONTAINMENT AREA SHALL BE LINED WITH 10 MIL PLASTIC SHEETING WITHOUT HOLES OR TEARS, WHERE THERE ARE SEAMS, THESE SHALL BE SECURED ACCORDING TO MANUFACTURERS' DIRECTIONS
- 4. THE BERM CONSISTING OF GRAVEL BAGS, CONCRETE BLOCKS OR OPEN GRADED ROCK SHALL BE NO LESS THAN 18 INCHES HIGH AND NO LESS THAN 12 INCHES WIDE. 5. THE PLASTIC SHEETING SHALL BE OF SUFFICIENT SIZE SO THAT IT WILL OVERLAP THE TOP OF THE CONTAINMENT AREA AND BE WRAPPED AROUND THE GRAVEL BAGS,
- CONCRETE BLOCKS OR OPEN GRADED ROCK AT LEAST 2 TIMES. 6. THE GRAVEL BAGS OR CONCRETE BLOCK SHALL BE PLACE ABUTTING EACH OTHER TO FORM A CONTINUOUS BERM AROUND THE OUTER PERIMETER OF THE CONTAINMENT
- 7. THE WASHOUT MATERIAL IN THE CONTAINMENT AREA SHALL NOT EXCEED 50% OF CAPACITY AT ANY TIME.
- 8. SOLIDS SHALL BE REMOVED FROM CONTAINMENT AREA AND DISPOSED OF PROPERLY.
  ANY DAMAGE TO THE PLASTIC SHEETING SHALL BE REPAIRED OR SHEETING REPLACED

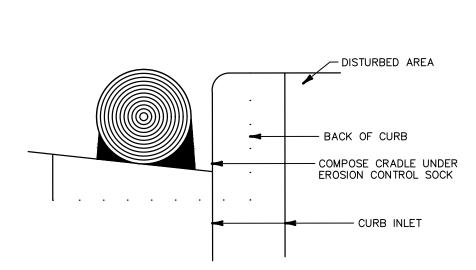

# GENERAL NOTES

1. LENGTHS OF EROSION CONTROL SOCKS SHALL BE IN ACCORDANCE WITH MANUFACTURER'S
RECOMMENDATIONS AND AS REQUIRED FOR
THE PURPOSE INTENDED. MAXIMUM LENGTH
OF SOCKS SHALL BE 30' FOR 12" DIAMETER SOCKS.
2. UNLESS OTHERWISE DIRECTED, USE
BIODEGRADABLE OR PHOTODEGRADABLE
CONTAINMENT MESH ONLY WHERE SOCK WILL
REMAIN IN PLACE AS PART OF A VEGETATIVE
SYSTEM. FOR TEMPORARY INSTALLATIONS,
USE RECYCLABLE CONTAINMENT MESH.
3. STUFF SOCKS WITH SUFFICIENT FILTER MATERIAL
TO ACHIEVE DENSITY THAT WILL HOLD SHAPE
WITHOUT EXCESSIVE DEFORMATION

WITHOUT EXCESSIVE DEFORMATION.

4. STAKES SHALL BE 2" X 2" WOOD

4' LONG, EMBEDDED SUCH THAT

2" PROTRUDES ABOVE SOCK.


5. COMPOST CRADLE MATERIAL IS INCIDENTAL


AND WILL NOT BE PAID FOR SEPARATELY.


OF 08


-STAKE ON DOWNHILL SIDE OF SOCK AT 8' CENTER TO CENTER OR LESS AS NEEDED TO ADEQUATELY SECURE SOCK. SECURE END OF SOCK TO DISTURBED AREA -BACK OF CURB 12" TEMP. EROSION - CONTROL SOCK PLAN VIEW

CURB INLET SEDIMENT TRAP

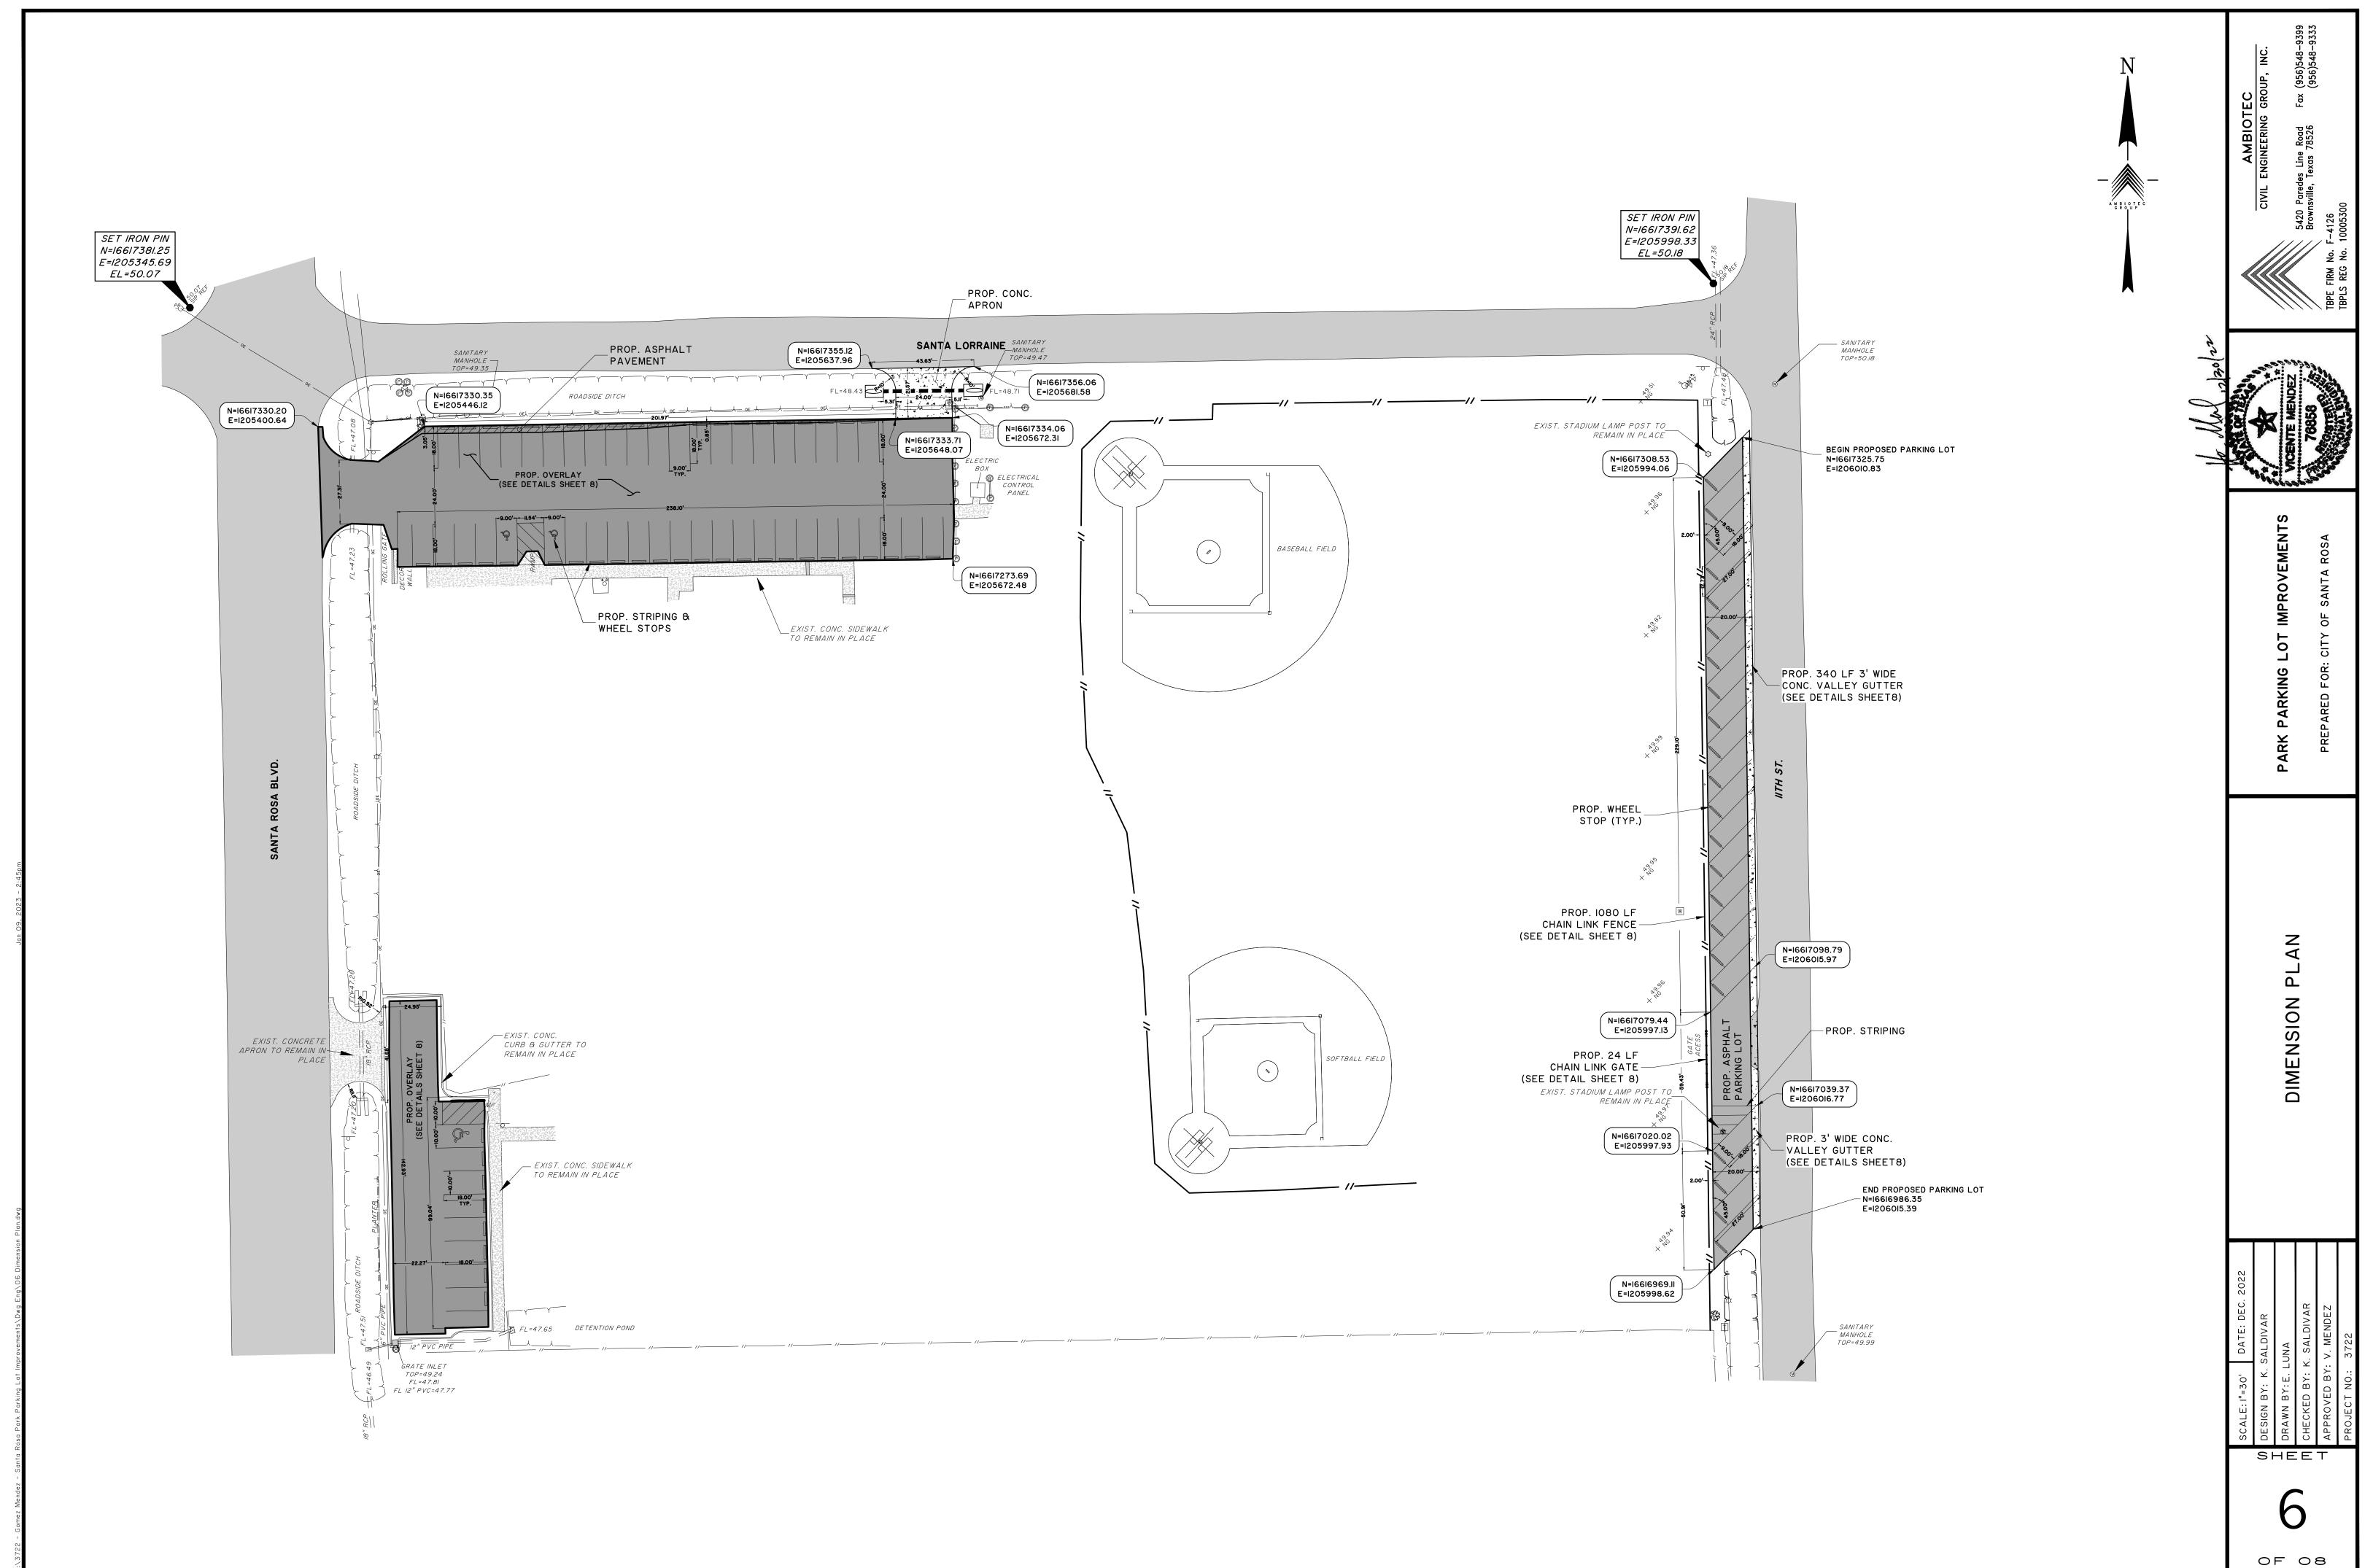

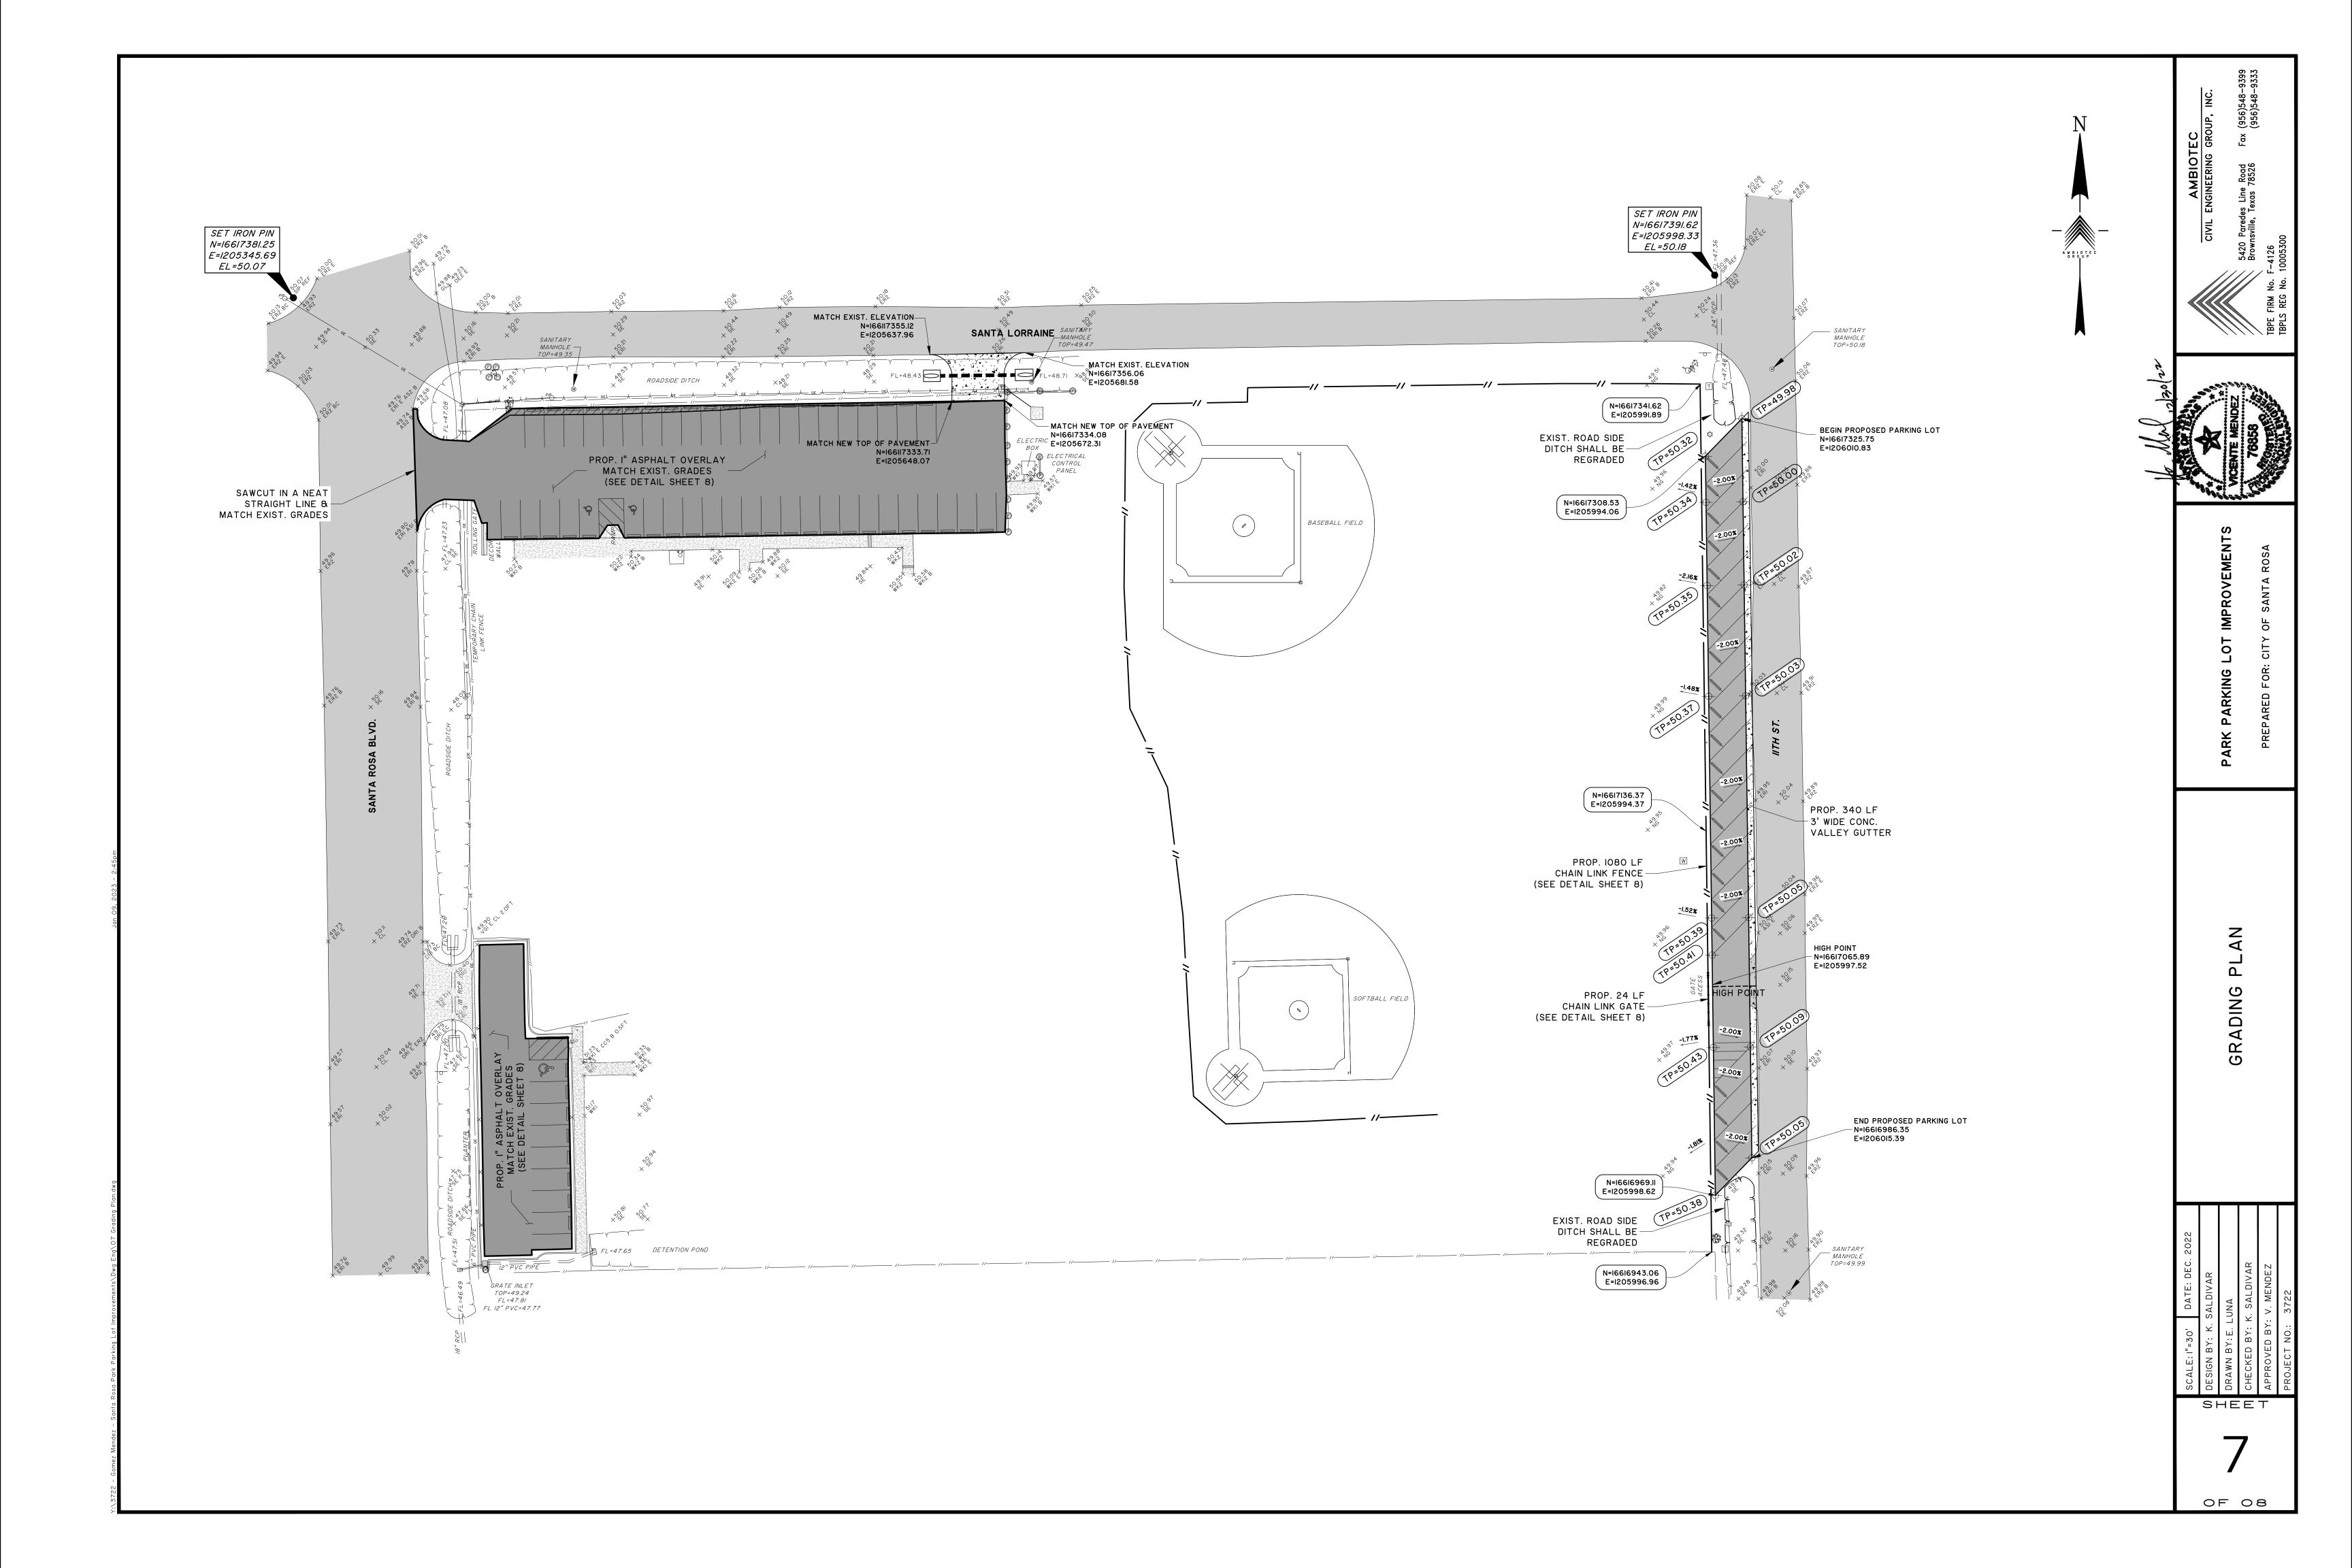

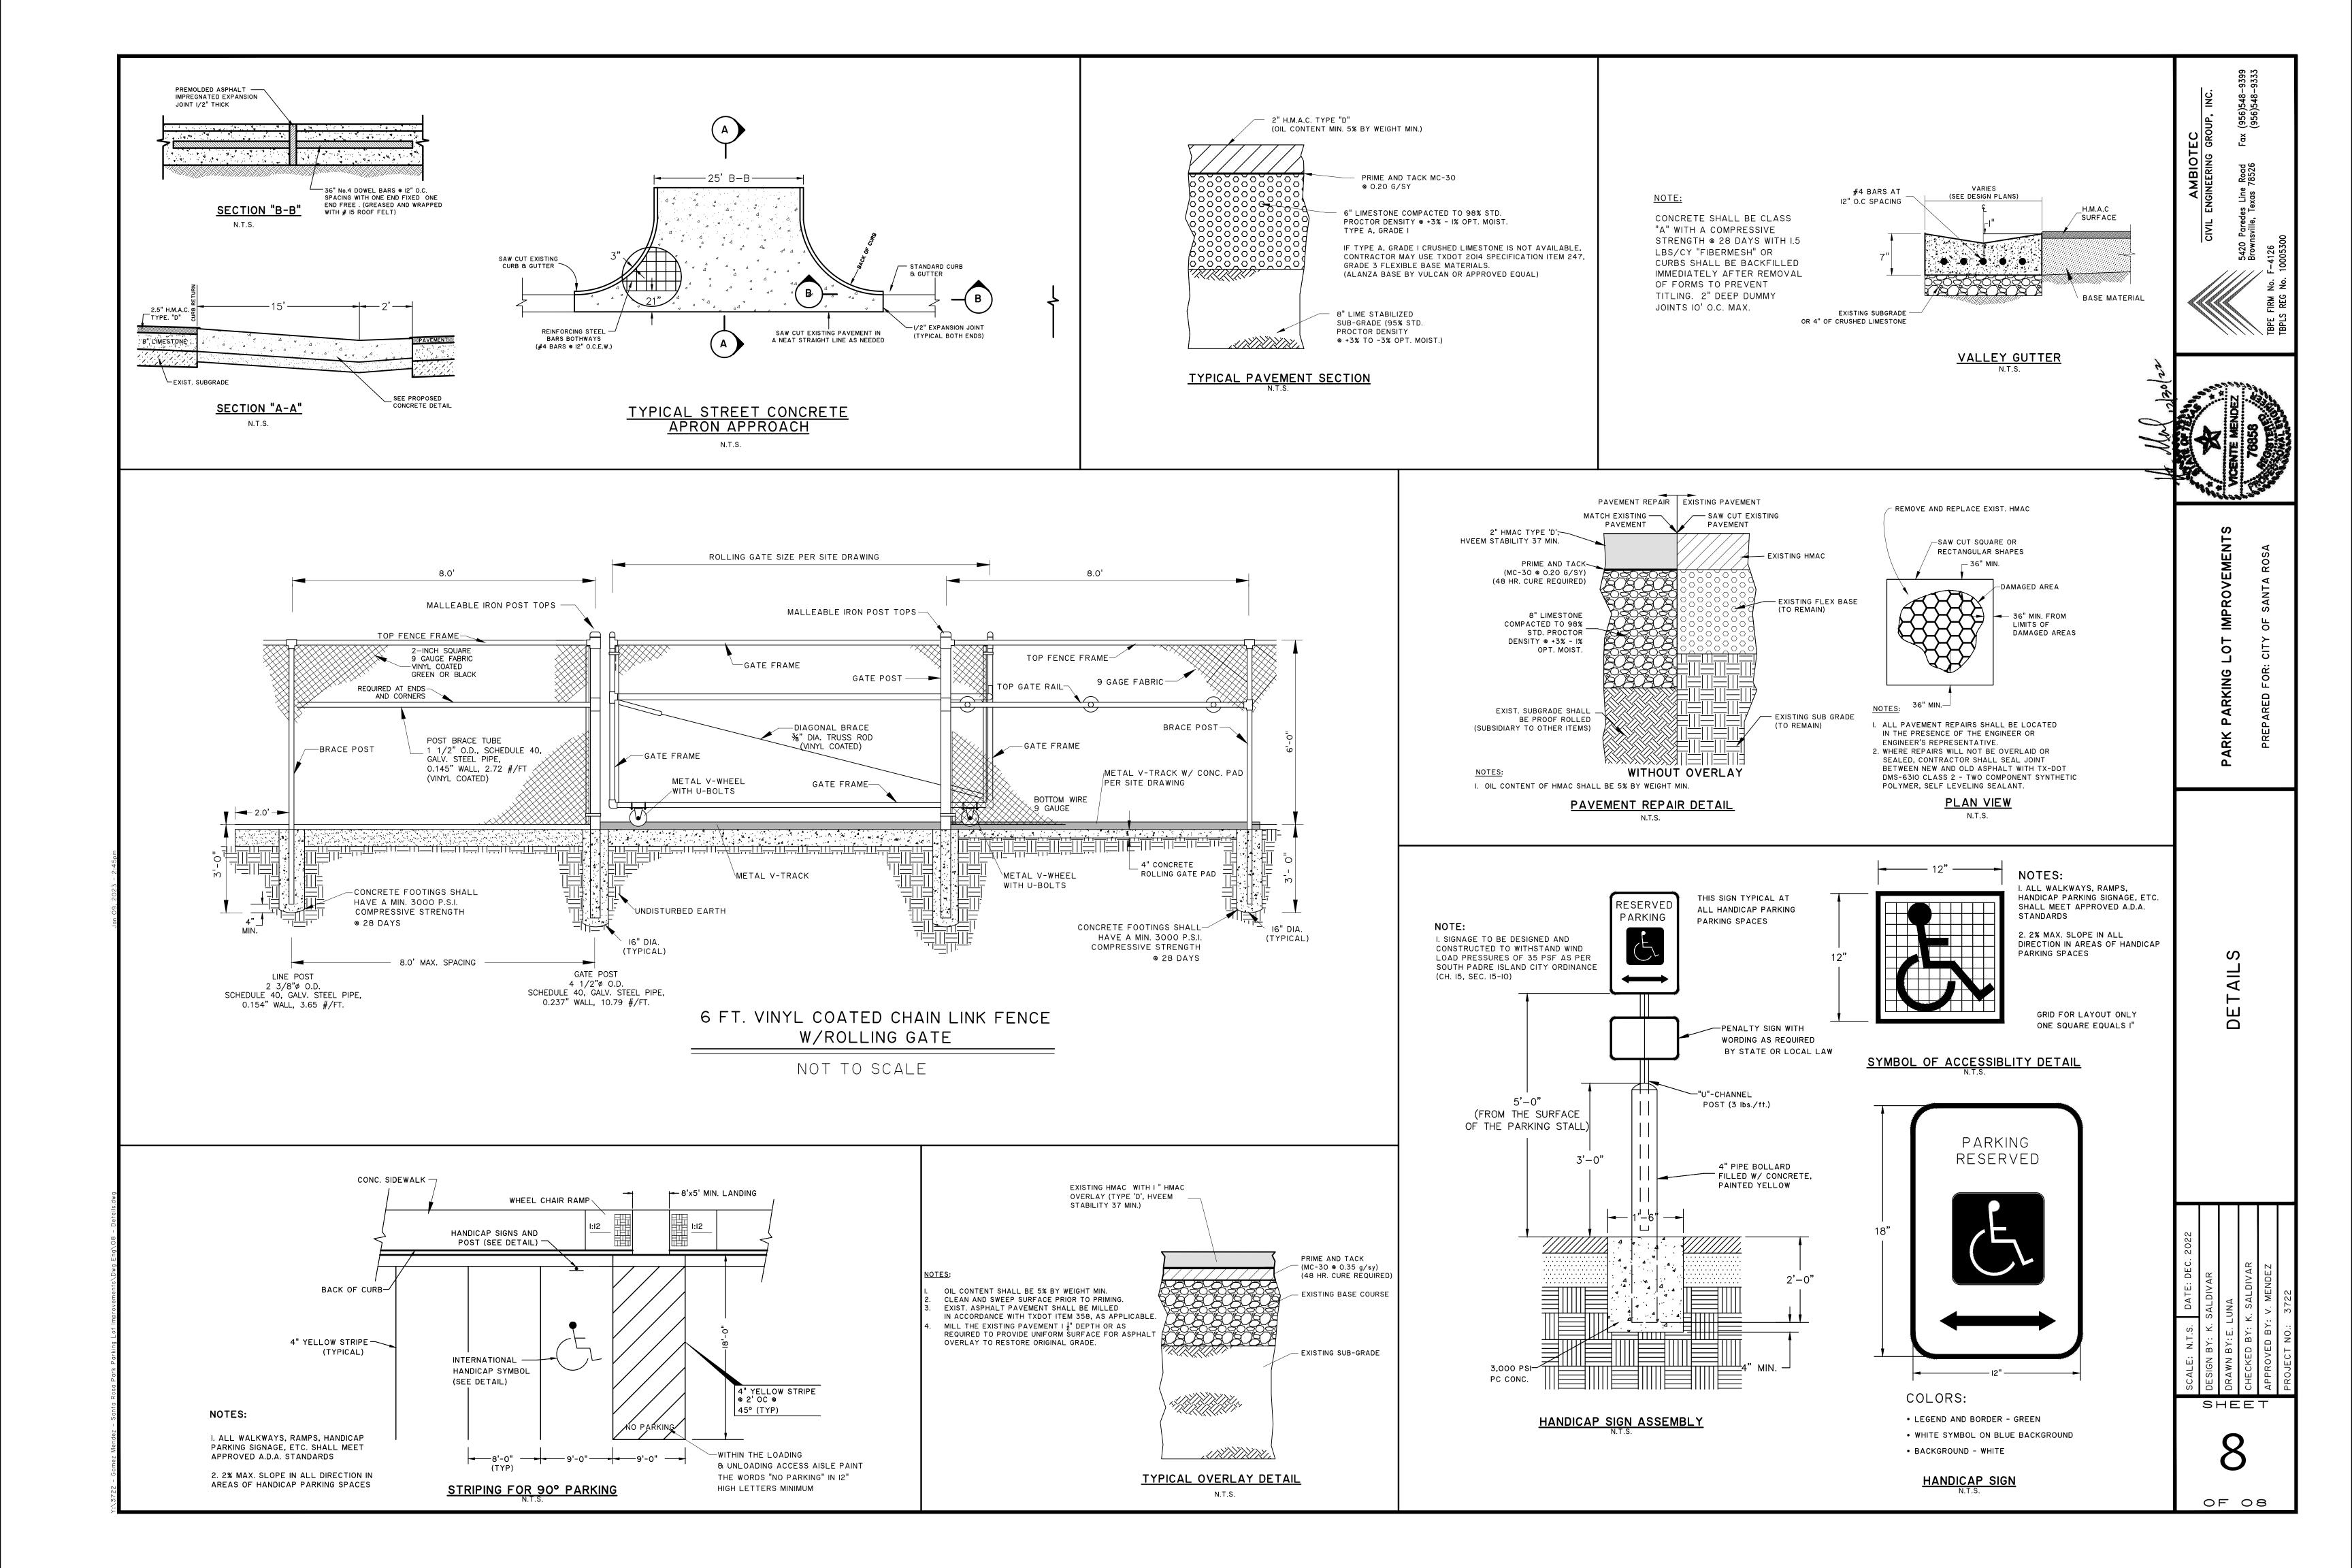

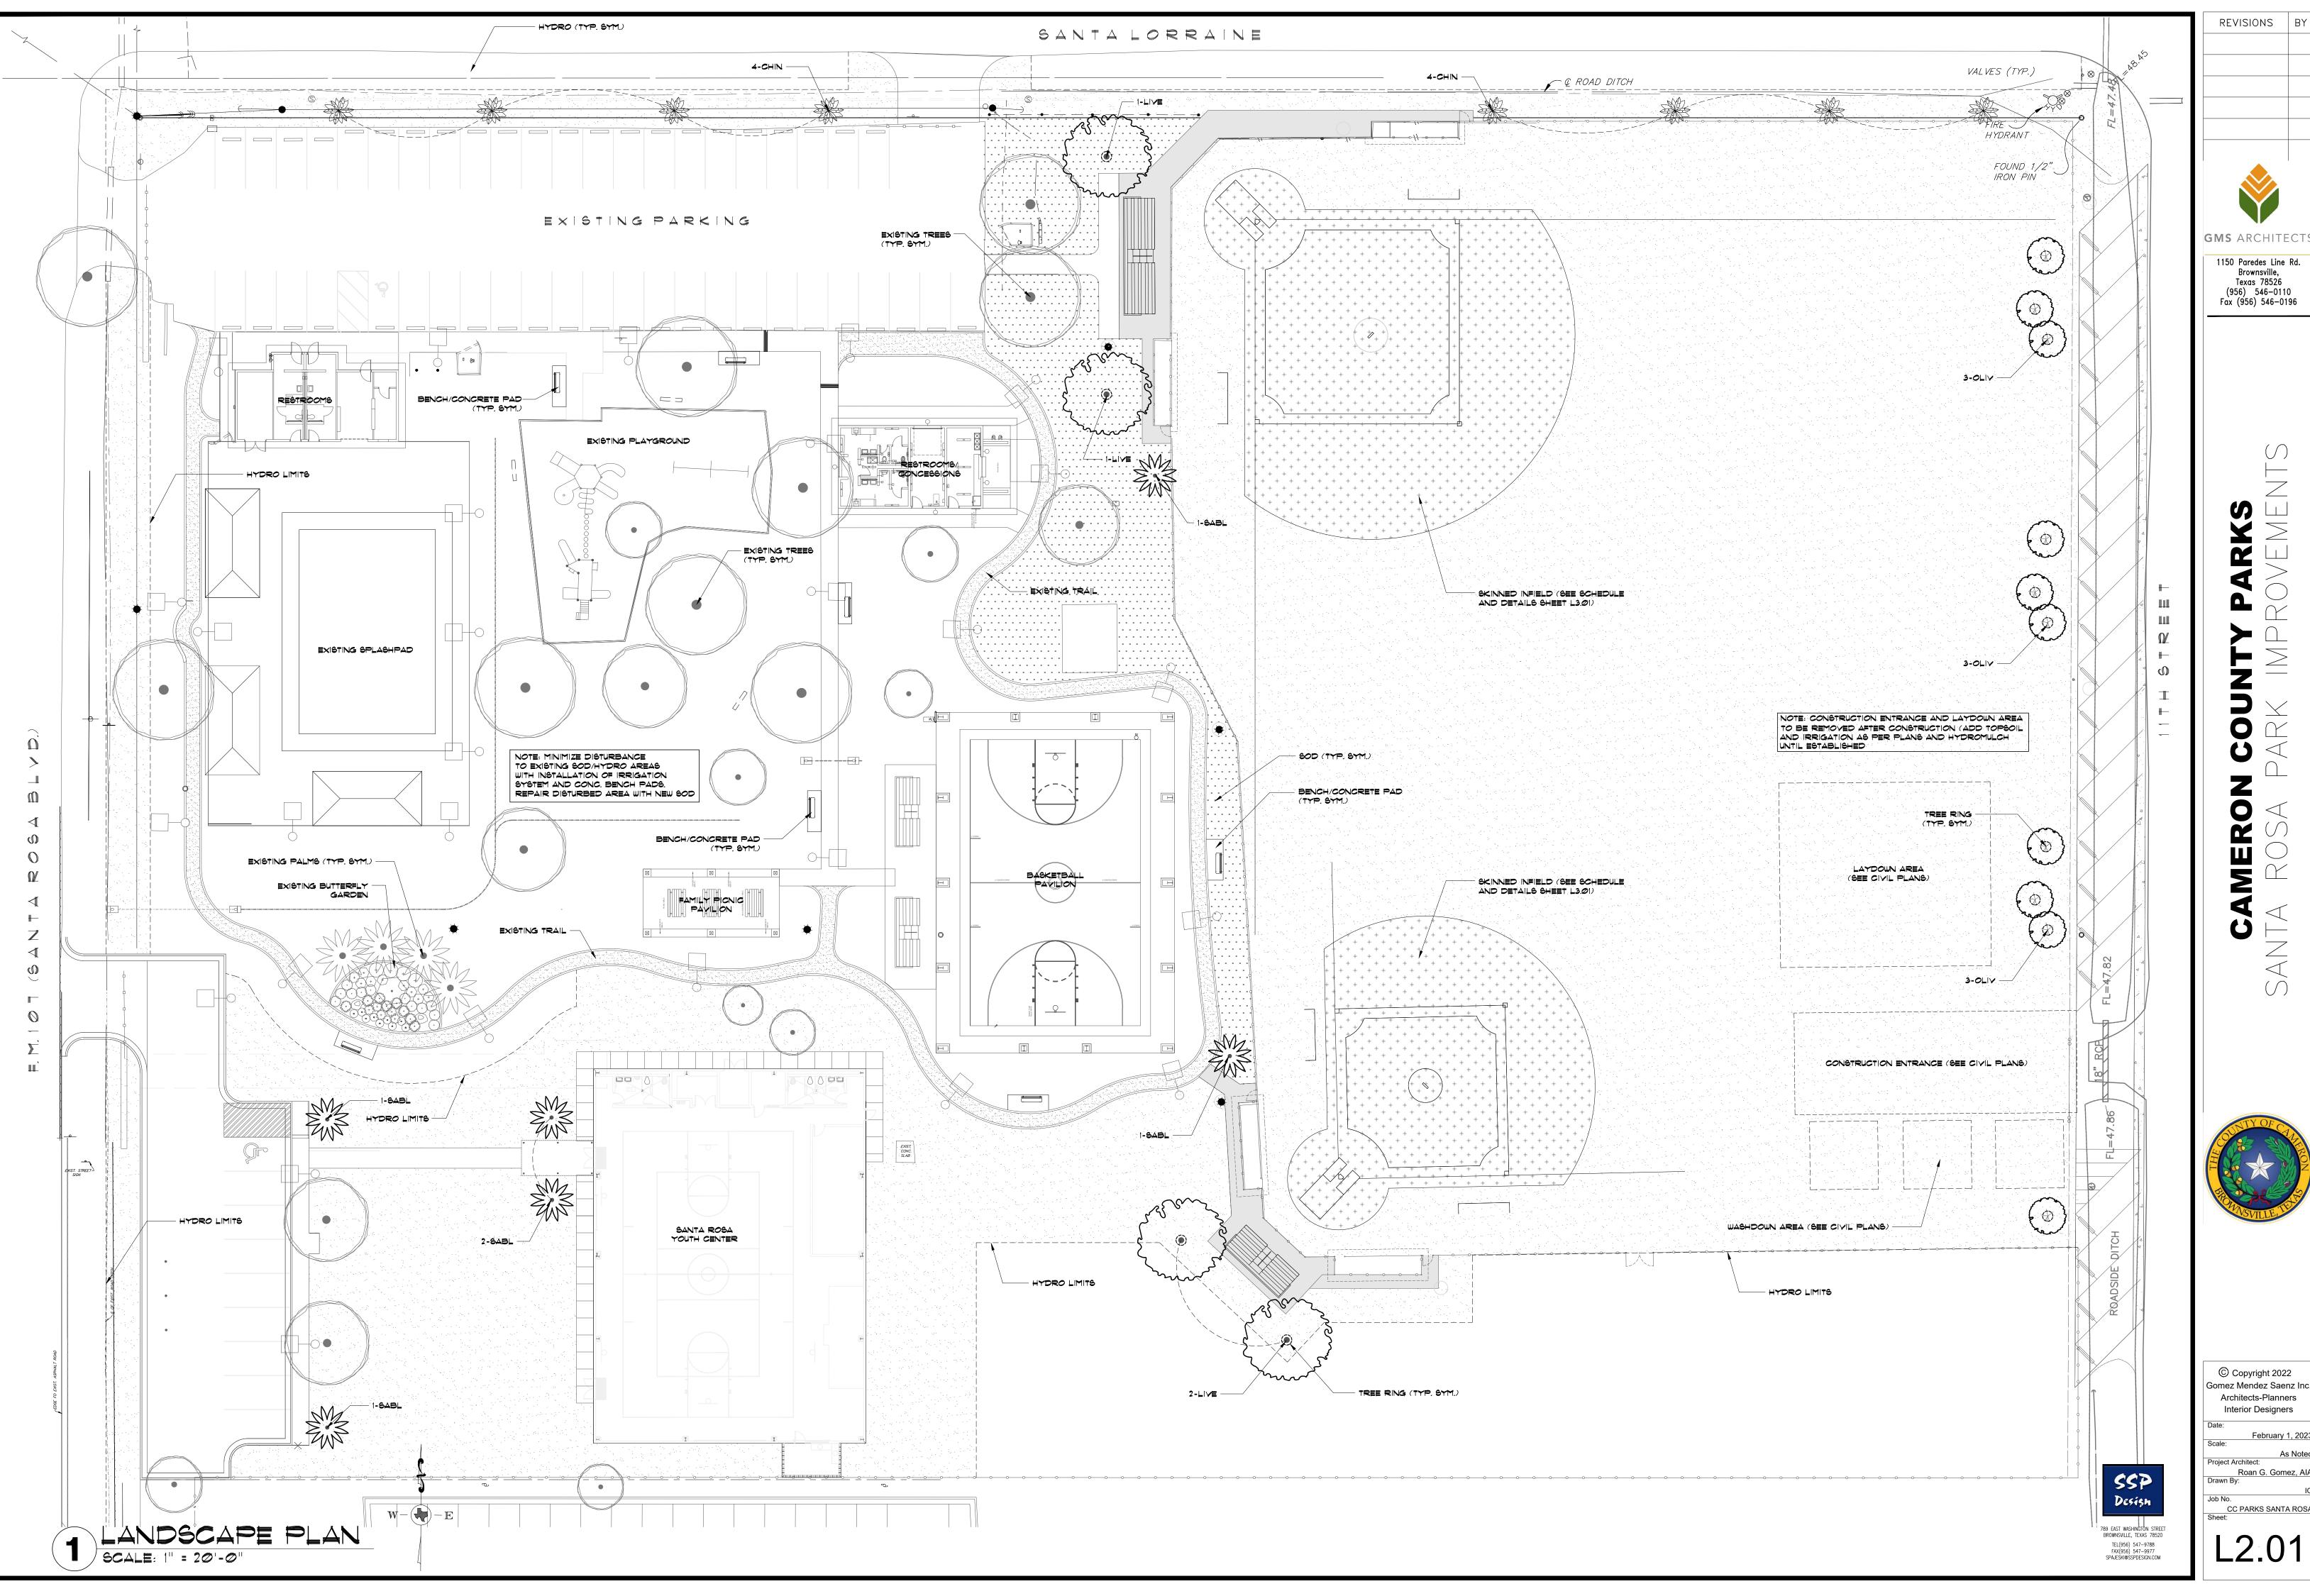

**GMS** ARCHITECTS 1150 Paredes Line Rd. Brownsville, Texas 78526 (956) 546-0110

AMER




© Copyright 2022 Architects-Planners Interior Designers Roan G. Gomez, AIA CC PARKS SANTA ROSA PREPARE TOPSOIL FOR SOD 1" BELOW INFIELD CLAY (SOD TO BE FLUSH WITH CLAY SURFACE)

TOP SOIL


Alvabration and interval and

# FIELD CLAY/SOD TRANSITION DETAIL


NOTE: GROW BAG TREES SHALL BE SIMMONS OAK FARMS (956) 425-5859 OR APPROVED EQUAL

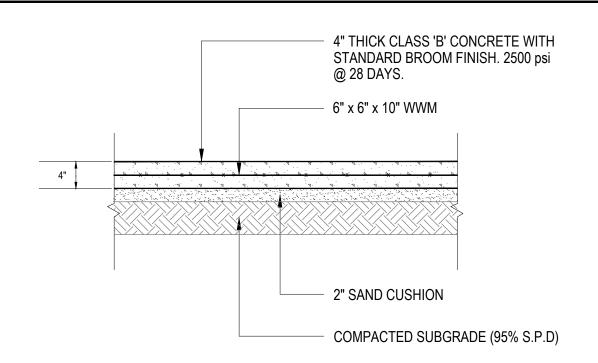

# 2 CONCRETE PAD DETAIL

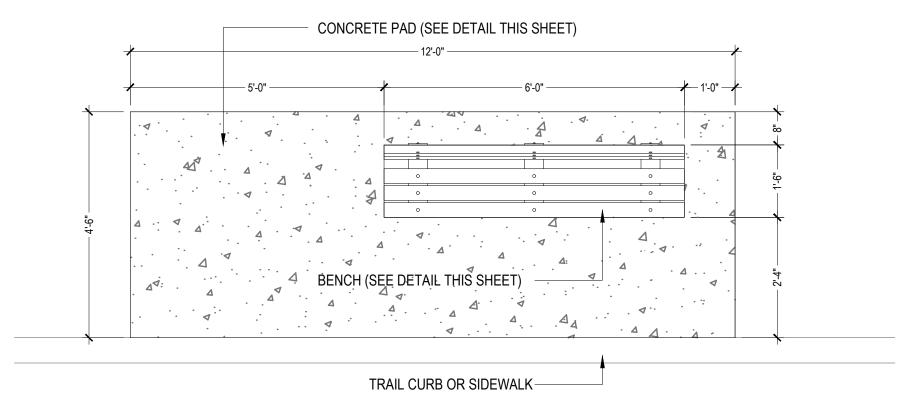

# 3 CONCRETE PAD/BENCH DETAIL

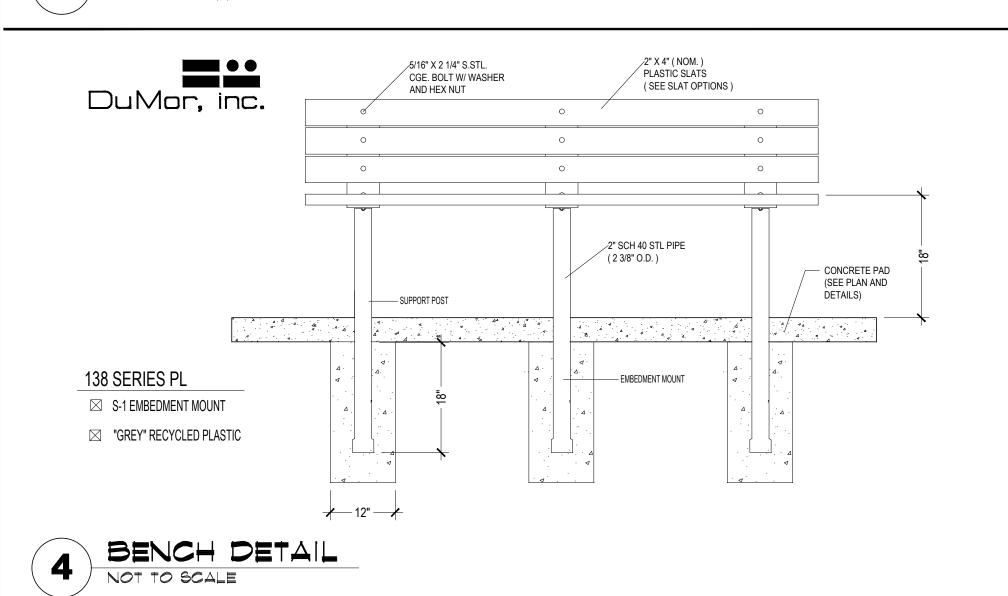


### MATERIAL SCHEDULE

DESCRIPTION	NOTES	QUANTITY
organic topsoil	2 BAG PER TREE/PALM- ORGANIC TOPSOIL	56 BAGS (2 C.F.)
PREMIUM COMPOST**	I BAG PER TREE/PALM- PREMIUM COMPOST	28 BAGS (2 C.F.)
Mulch (Hardwood)	2 BAGS PER TREE/PALM IN WATERING BASIN- TEXAS NATIVES HARDWOOD	56 BAGS (2 C.F.)
FERTILIZER	ALL PLANT MATERIAL PER DETAILS	-
PLANTING TABLETS	PER DETAILS / AS SPECIFIED	
GUYING / STAKING	all trees/palms with safe-t caps on posts per details	
TREE RINGS	36" DIA, 5" COMMERCIAL GRADE ALUMINUM EDGE 'DREAMSCAPE' TREE RINGS PER PLAN/DETAILS	14
CONCRETE PADS	4" THICK CONCRETE PADS FOR PARK BENCHES AS PER PLANS/DETAILS	400 S.F.
BENCH	Du Mor 6' Length 138-60PL Recycled Plastic Slats (GREY) S-1 EMBEDMENT MOUNT WITH POWDER COATED POST (BLACK)	Т
INFIELD MIX	6" LAYER OF INFIELD MIX - 60% SAND, 20% SILT, 20 % CLAY 1/4" MINUS RED COLOR	324 C.Y.
INFIELD CONDITIONER	1/2" MIXED/TILLED DIAMOND PRO RED INFIELD CONDITIONER	24 TONS
INFIELD GRADING	COMPLETE INFILED LASER GRADING PER NOTES BELOW	
IRRIGATION SYSTEM	COMPLETE AUTOMATIC IRRIGATION SYSTEM PER PLANS/DETAILS BY LICENSED CONTRACTOR	


- 1. CONTRACTORS MUST REVIEW TECHNICAL SPECIFICATIONS FOR ADDITIONAL PRODUCT INFORMATION AND PROJECT REQUIREMENTS, \* AVAILABLE AT KINNEY BONDED WAREHOUSE (956) 464-4491
- \*\* CUTTING EDGE PREMIUM QUALITY COMPOST HOME DEPOT OR APPROVED EQUAL

#### SPORTS FIELD NOTES

- 1. APPLY HERBICIDE/ROUNDUP TO ENTIRE FIELD AREA UNTIL ALL VEGETATED MATTER IS ERADICATED
- 2. Clear and grub (remove all debris) from field area
- 3. RIP/TILL SOIL WITH AN AGRICULTURAL CULTIVATOR TO A DEPTH OF 6" ON FIELD, 3" ON OUTFIELD
- 4. ROUGH GRADE INFIELDS TO PREPARE FOR 6" LAYER OF INFIELD MIX
- 5. APPLY INFIELD MIX AND FINE GRADE TO FINISHED ELEVATIONS ON CIVIL PLANS
- 6. CONTRACTOR TO GRADE FIELD WITH SPECIFIED CROWN/SLOPES UTILIZING FULLY AUTOMATED COMPUTERIZED DUAL GPS SYSTEM WITH LASER AUGMENTATION TO ACHIEVE GRADES WITHIN 1/4" TOLERANCE, FIELD MUST DRAIN SMOOTHLY WITH NO BIRD BATHS OR LOW SPOTS
- 7. INSTALL IRRIGATION PER PLANS/SPECS. THOROUGHLY WATER IN WITH MULTIPLE WATERINGS
- 8. FIELD DRAINAGE WILL BE TESTED AND REVIEWED BY SSP PRIOR TO SOD OR HYDORMULCH.
- 9. Install sod or hydromulch as per plans and specifications
- 10. ROLL FIELDS WITH 2 TON MECHANICAL ROLLER/VIBRATOR. TOP DRESS WITH CLEAN SAND ALL LOW SPOTS OR DIVOTS
- 11. MONITOR WATERING FOR CONTINUOUS MOISTURE ON HYDROMULCH UNTIL FULL GERMINATION.
- 12. COMMENCE MOWING USING A REEL TYPE MOWER ONLY. MOWING SHALL BE AT LEAST ONCE PER WEEK AND MUST BE REVIEWED, CHECKED AND APPROVED BY SSP ON OR ABOUT 45 DAYS AFTER INSTALLATION/GERMINATION, FERTILIZE WITH HJ 25-0-0 WITH WOLFTRAX OR APPROVED EQUAL AT MANUFACTURERS RATES

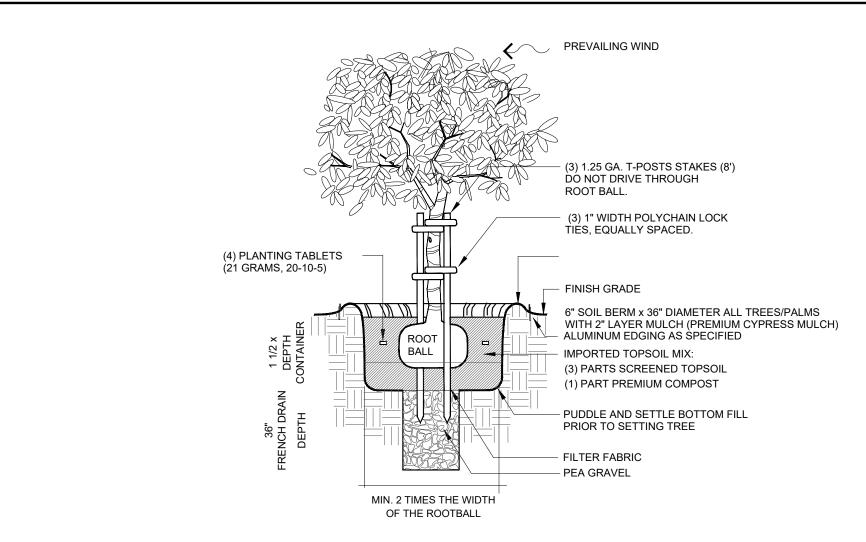

# 5 TREE PLANTING DETAIL

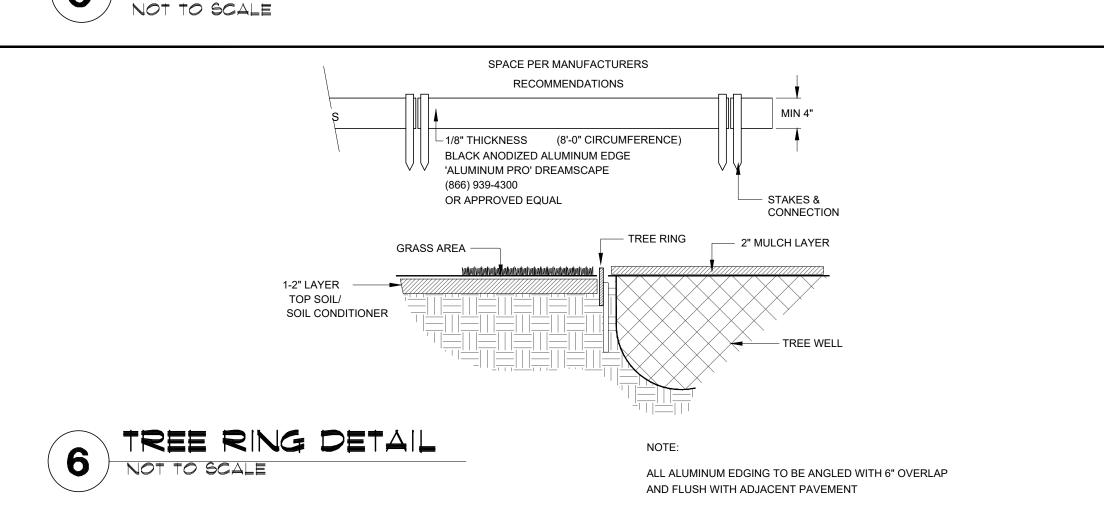

#### CONSTRUCTION NOTES

VERIFICATION/INTERPRETATION OF PLANS.

- 1. WORK UNDER THIS CONTRACT INCLUDES SITE REVIEW AND COORDINATION WITH EXISTING CONDITIONS, SITE CLEANUP, EXCAVATION, BED PREP, TILLING, PLANTING, STAKING, EDGING, IRRIGATION, TREE RINGS, INFIELD CLAY, SITE FURNITURE, MAINTENANCE, AND GUARANTEE.
- 2. LANDSCAPE CONTRACTOR SHALL VERIFY ALL QUANTITIES AND DIMENSIONS PRIOR TO BIDDING.
  QUANTITIES SHOWN IN SCHEDULE ARE FOR CONVENIENCE ONLY.
- 3. NOTIFY SSP DESIGN OF ANY DISCREPANCIES IN DRAWINGS/DETAILS OR INSUFFICIENT QUANTITIES DUE TO DIFFERENCES IN PLAN AND ACTUAL FIELD CONDITIONS.
- 4. LANDSCAPE CONTRACTOR SHALL BE RESPONSIBLE FOR LOCATING AND PROTECTING ALL EXISTING UTILITIES. SPOTTING OF ALL UTILITIES IS REQUIRED.
- 5. NOTIFY AND MEET WITH SSP DESIGN PRIOR TO ANY CONSTRUCTION FOR
- 6. LANDSCAPE CONTRACTOR SHALL STAKE OUT ALL BEDS, TREES, PALM LOCATIONS PRIOR TO INSTALLATION FOR APPROVAL BY SSP DESIGN.
- 7. CONTRACTOR TO COORDINATE WITH SSP DESIGN TO ENSURE PROPER PLACEMENT OF PLANT MATERIAL AND IRRIGATION EQUIPMENT.
- 8. CONTRACTOR TO INSTALL EXTRUDED CONCRETE EDGE AND TREE RINGS AS SHOWN ON PLANS.
- 9. NOTIFY SSP DESIGN/OWNER PRIOR TO PLANTING OPERATIONS FOR APPROVAL OF ALL PLANT MATERIAL ON SITE, ANY PLANT MATERIAL NOT APPROVED BY SSP DESIGN/OWNER WILL BE SUBJECT TO REJECTION.
- 10. IRRIGATION CONTRACTOR SHALL SUPPLY AND INSTALL COMPLETE AUTOMATIC IRRIGATION SYSTEM INCLUDING WATER METER, BACKFLOW DEVICE, CONTROLLER, MAINLINE, SLEEVES, DRIP, TO COVER ALL LANDSCAPE AREAS PER PLANS/DETAILS.
- IRRIGATION SYSTEM SHALL BE INSTALLED BY A TEXAS LICENSED IRRIGATOR ONLY.

  11. CONTRACTOR SHALL REMOVE ALL EXISTING GRASS/WEEDS IN BEDS BY HERBICIDING PRIOR TO
- BED PREP AND SOIL REPLACEMENT.

  12. CONTRACTOR SHALL PRUNE ALL EXISTING PALMS/TREES BY A CERTIFIED ARBORIST AS
- DIRECTED BY SSP DESIGN.


  13. CONTRACTOR SHALL REMOVE ALL EXISTING GRASS AND WEEDS BY HERBICIDING, DISKING,
- FLOATING AND LIGHT GRADING OF ENTIRE PROJECT AREA PRIOR TO HYDROMULCHING/SODDING.
- 14. CONTRACTOR SHALL REMOVE 12" OF EXST'G SOIL WITHIN ALL BED AREAS AND REPLACE WITH IMPORTED TOP SOIL/PREMIUM COMPOST MIX.
- 15. LANDSCAPE CONTRACTOR SHALL CONSTRUCT 6"x36" WATERING BASINS AROUND ALL TREES/PALMS WITH A MIN. 2" LAYER OF CYPRESS MULCH.
- 16. LANDSCAPE CONTRACTOR SHALL LOOSEN / GRADE ALL LAWN AREAS PRIOR TO
- HYDRO-MULCHING/SODDING TO ENSURE PROPER DRAINAGE AND UNIFORM SURFACE.

  17. LANDSCAPE CONTRACTOR SHALL ESTABLISH AND MAINTAIN ALL PLANT MATERIAL

  FOR 30 DAYS AFTER 'SUBSTANTIAL COMPLETION' AND SHALL GUARANTEE ALL TREES/PALMS
- FOR A PERIOD OF ONE YEAR.

  18. IRRIGATION CONTRACTOR SHALL GUARANTEE ALL SYSTEM COMPONENTS FOR A PERIOD
- OF ONE YEAR.

  19. SEE SPECIFICATION FOR FURTHER INSTRUCTIONS/REQUIREMENTS.

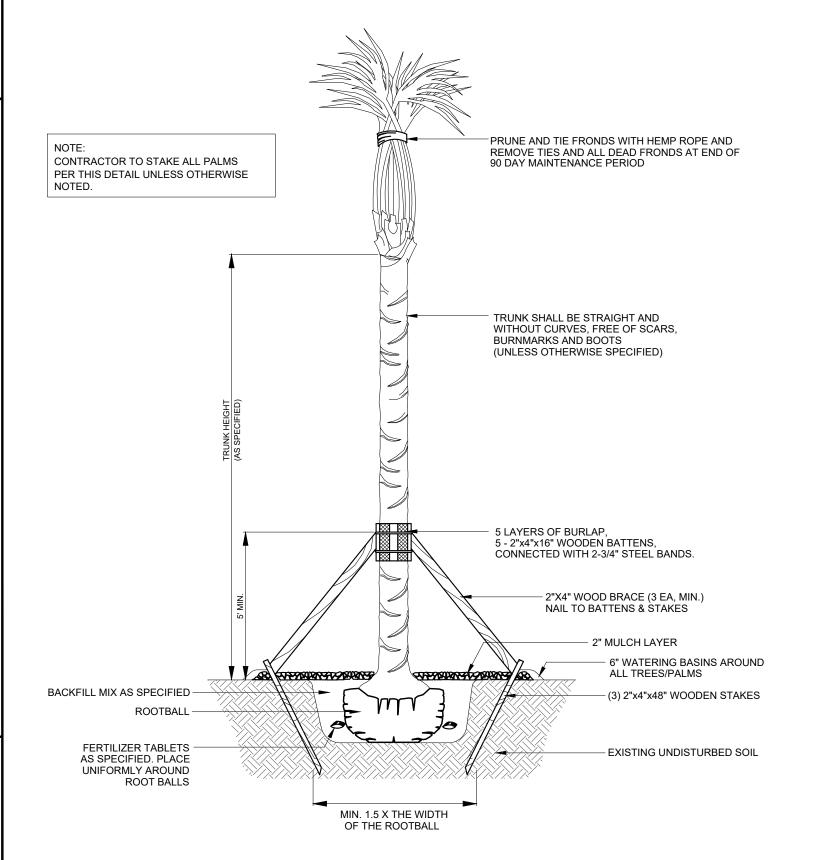





REVISIONS



1150 Paredes Line Rd.
Brownsville,
Texas 78526
(956) 546-0110
Fax (956) 546-0196

CAMERON COUNTY PARKS
SANTA ROSA PARK IMPROVEMEN




© Copyright 2022
Gomez Mendez Saenz Inc.
Architects-Planners
Interior Designers

Date:
February 1, 2023
Scale:
As Noted
Project Architect:
Roan G. Gomez, AIA
Drawn By:

CC PARKS SANTA ROSA

13.0

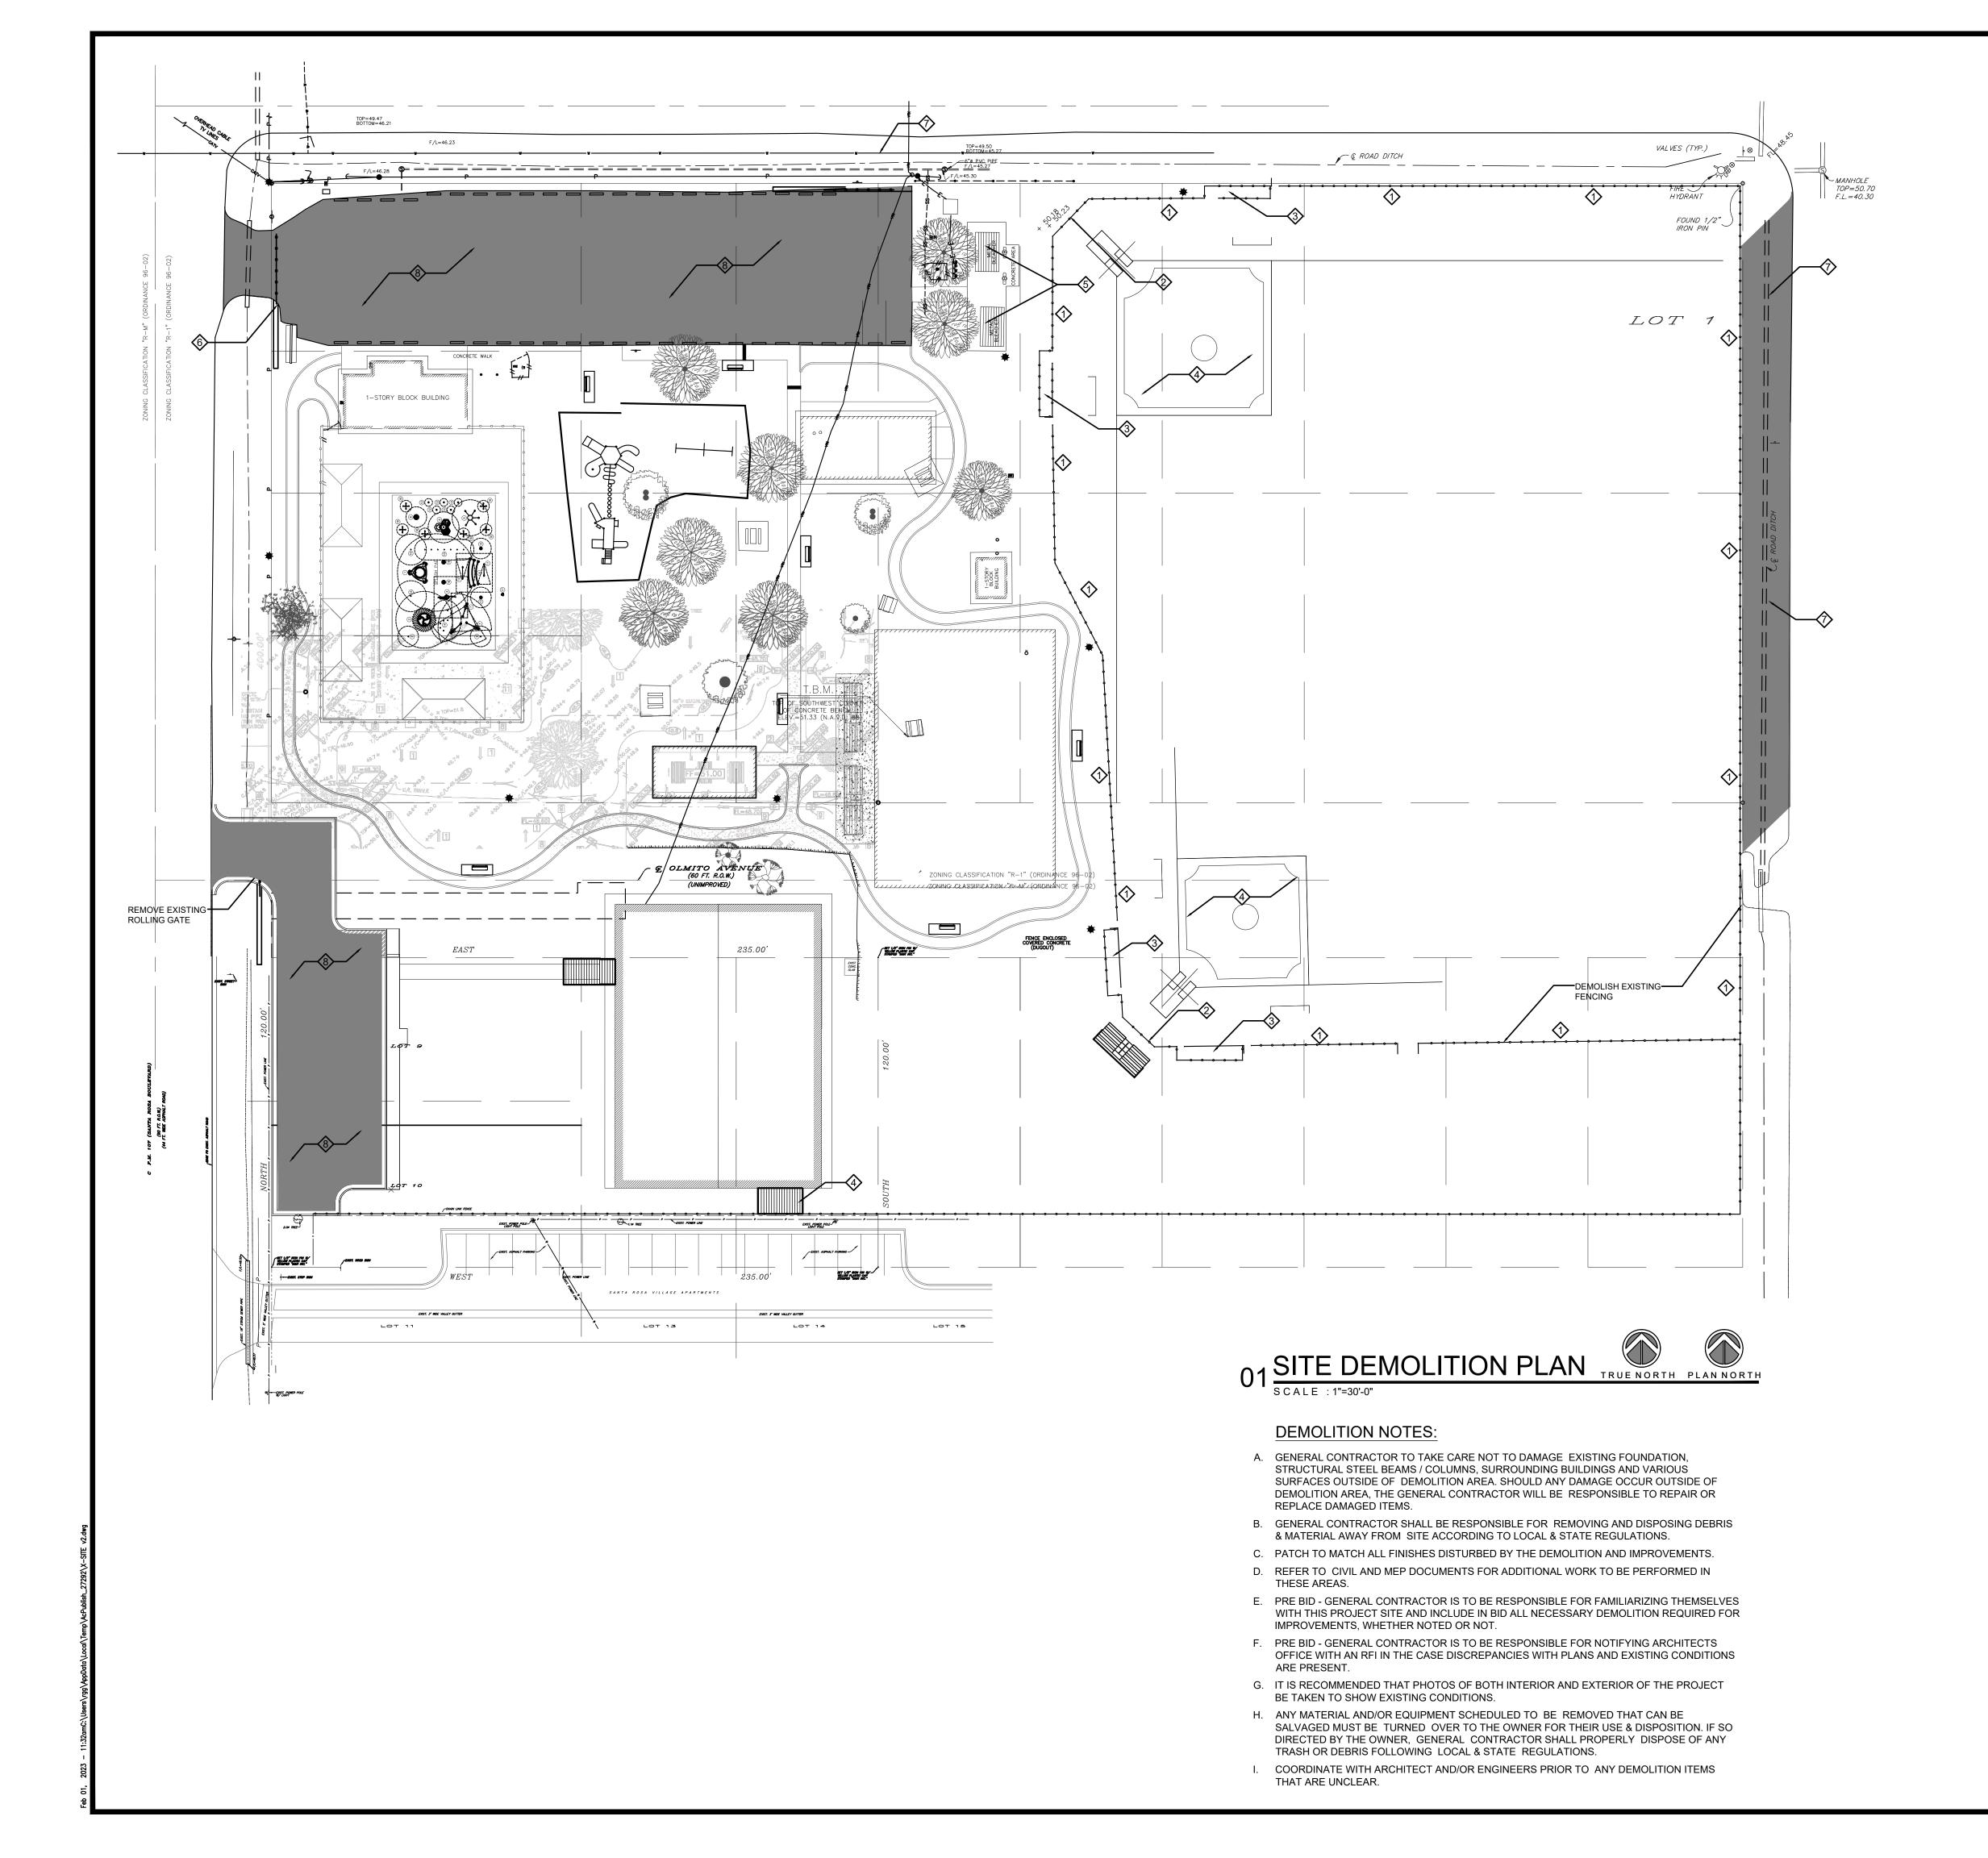

#### KEYED DEMOLITION NOTES:


- DEMOLISH EXISTING CHAIN LINK FENCING.
- DEMOLISH EXISTING CHAIN LINK BACKSTOP
- 3 DEMOLISH EXISTING COVERED DUGOUTS.
- CLEAR VEGETATION AND STRIP TOPSOIL.
- 5 DEMOLISH EXISTING CONCRETE PAD AND BLEACHERS.
- 6 DEMOLISH EXISTING ACCESS GATE.
- CLEAR VEGETATION FOR ADDITIONAL PAVING IMPROVEMENTS.
- PREPARE ASPHALT PARKING AREAS FOR IMPROVEMENTS.
- √9> xx

REVISIONS BY

GMS ARCHITECT

1150 Paredes Line Rd.
Brownsville,
Texas 78526
(956) 546-0110
Fax (956) 546-0196

OVEMENT

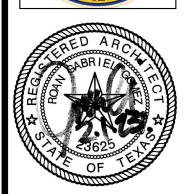

© Copyright 2023
Gomez Mendez Saenz Inc.
Architects-Planners
Interior Designers

JANUARY 2023
Scale:

As Noted
Project Architect:
Roan G. Gomez, AIA
Drawn By:

Job No.

SANTA ROSA - PHASE 2

Sheet:

D1.01

# **KEYED NOTES**

- CONCRETE WALK AS DIMENSIONED, REFER TO DTL'S 01, 02,03 THIS SHEET
- 02 ASPHALT OVERLAYAT EXISTING LOTS
- DROVIDE (4) 221 V 5 DOWN DICKET CHAI
- PROVIDE (1) -33' X 5 ROW PICKET GUARD RAIL ALUMINUM BLEACHERS, FASTEN TO CONCRETE FOUNDATION. MODEL # BGS-126 BY BELSON OUTDOORS 1-800-323-5664, WWW.BELSON.COM
- 04 20'-0" HIGH GALVANIZED CHAIN LINK BACKSTOP.
- PROVIDE (1) -21' X 5 ROW PICKET GUARD RAIL ALUMINUM BLEACHERS, FASTEN TO CONCRETE FOUNDATION. MODEL # BGS-008 BY BELSON OUTDOORS 1-800-323-5664, WWW.BELSON.COM
- 06 4'-0" HIGH GALVANIZED CHAIN LINK FENCE WITH DOUBLE 4'-0" GATES TO BE LOCATED BY ARCHITECT.
- 07 25'-0" WIDE DUGOUTS WITH FULL HEIGHT CHAIN LINK SURROUND
- 08 PREFINISHED METAL CANOPY AT DUGOUTS
- 09 CLAY BASEBALL INFIELD.
  REFER TO LANDSCAPE FOR ADDITIONAL INFORMATION
- 10 IRRIGATION SYSTEM AT BASEBALL FIELDS
- REFER TO LANDSCAPE FOR ADDITIONAL INFORMATION

  BASEBALL FIELD LIGHTING REFER TO ELECTRICAL
- 12 PARK BENCHES. REFER TO LANDSCAPE
- 9'-0" TALL PERFINISHED METAL WALKWAY CANOPY

  CONCESSION ROOM ADDITION
- 15 CONCESSION ROOM ADDITION
- 28'-0" WIDE, 6'-0" TALL ROLLING CHAIN LINK TRAFFIC GATE ON V-TRACK. REFER TO SHEET A1.02

TRUENORTH PLANNORTH

# 01 OVERALL SITE PLAN

### SCALE : 1/16"=1'-0"

### SITE NOTES:

- 1.) FINISH GRADE TO BE 6" BELOW FINISH FLOOR ELEVATION SLOPE AWAY FROM ALL IMPROVEMENTS AT A RATE OF 1/4" PER FOOT FOR THE FIRST 10'-0"; THEN AT A RATE OF 1/8" PER FOOT FOR THE NEXT 20'-0"
- 2.) SIDE WALK SLOPE IS NOT TO EXCEED 1:20 WITH A CROSS SLOPE OF 1:50 AT ANY INSTANCE.
- 3.) REFER TO CIVIL, LANDSCAPE AND MECHANICAL DRAWINGS FOR ADDITIONAL WORK TO BE PERFORMED UNDER THIS CONTRACT.
- 4.) PLAY FIELDS, TRAFFIC STRIPPING & TRAFFIC SIGNS NOT SHOWN FOR CLARITY. REFER TO ARCHITECTURAL SHEETS A1.09 THRU A1.13 FOR NOTATION AND REQUIREMENTS
- 5.) AT ALL ENTRIES OF NEW BUILDINGS WARP CONCRETE SIDEWALKS SO AS TO PROVIDE A FLAT SURFACE WITH FINISHED FLOOR
- 6.) GENERAL CONTRACT TO TAKE CARE NOT TO DAMAGE EXISTING SODDED AREA OR VARIOUS ELEMENTS OUTSIDE THE LIMITS OF WORK AND SHALL PROVIDE PROTECTION NECESSARY TO PREVENT DAMAGE TO EXISTING STRUCTURES TO REMAIN IN PLACE. SHOULD ANY DAMAGE BE CAUSED BY THE CONSTRUCTION PROCESS OUTSIDE OF REMOVAL & SITE CLEARING AREA, THE GENERAL CONTRACTOR IS TO BE RESPONSIBLE TO REPAIR OR REPLACE DAMAGED AREAS AT NO COST TO THE OWNER.
- 7.) PROVIDE TEMPORARY CONSTRUCTION FENCE ENSURE THAT CONSTRUCTION SITE IS SECURE FROM ANYONE THAT MAY VISIT THE SITE ENSURE CONSTRUCTION FENCE IS A MINIMUM OF 6'-0" HIGH CHAIN LINK FENCE OR APPROVED EQUAL




REVISIONS BY

1150 Paredes Line Rd. Brownsville, Texas 78526 (956) 546-0110 Fax (956) 546-0196

CAMERON COUNTY PARKS
ANTA ROSA PARK IMPROVEMENT



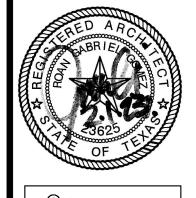

© Copyright 2023
Gomez Mendez Saenz Inc.
Architects-Planners
Interior Designers


JANUARY 2023
Scale:

As Noted
Project Architect:
Roan G. Gomez, AIA
Drawn By:

Job No.
SANTA ROSA - PHASE 2
Sheet


A1.01

01 SIDEWALK CONTROL JT. SCALE: 1-1/2"=1'-0"

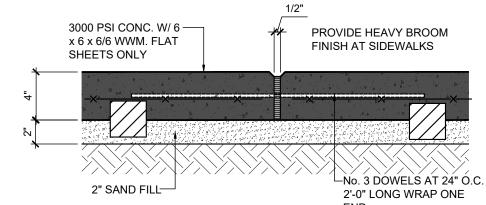

02 SIDEWALK EXP. JT. DETAIL

04SIDEWALK DETAIL

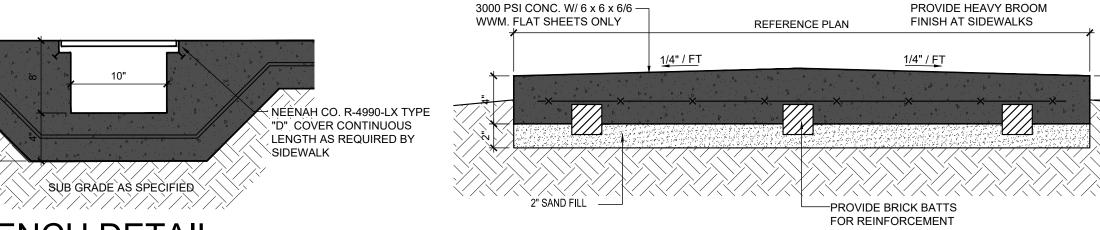



03 TRENCH DETAIL


SCALE 1 1/2" = 1'-0"

1.) CONTRACTOR TO VERIFY ALL BUILDING ROOF DRAINS & DOWN SPOUTS THAT WILL SPILL ONTO A SIDEWALK AND PROVIDE A TRENCH GUTTER AT THAT LOCATION TO ALLOW FOR RAIN WATER TO DRAIN THRU GUTTER AND NOT OVER SIDEWALK ( WHICH COULD CAUSE A TRIPPING HAZARD ). CONTRACTOR TO VERIFY TRENCH GUTTERS NEEDED PRIOR TO ANY POURING OF SIDEWALKS AROUND PERIMETER OF BUILDING. TYPICAL AT ALL BUILDINGS.

2.) REFER TO CIVIL DRAWINGS FOR ALL OTHER LOCATIONS OF TRENCH GUTTERS

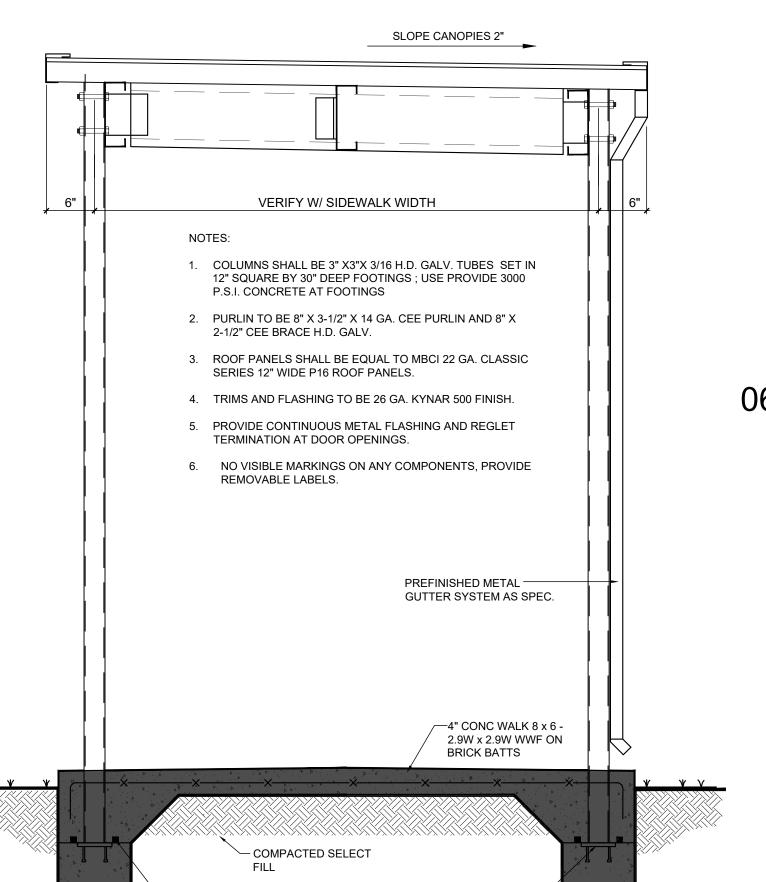

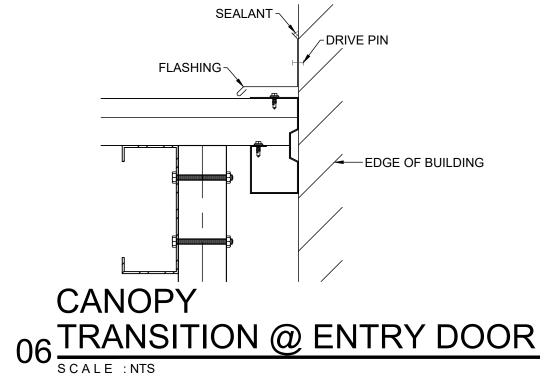

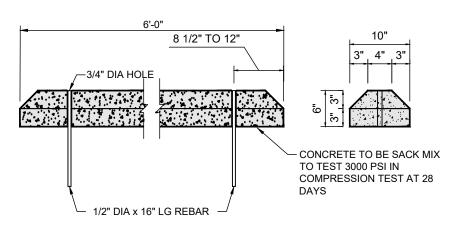

07CONCRETE TIRE STOP

05 SECTION DETAIL

SCALE 3/4" = 1'-0"

-"SYNKOFLEX" WATERSTOP CON.T

AROUND COLUMN


VAPOR BARRIER

—6 MIL POLYETHYLENE

TUBE COLUMN WELDED —

TO 5" x 5" IMBED PLATE


IN FOOTING

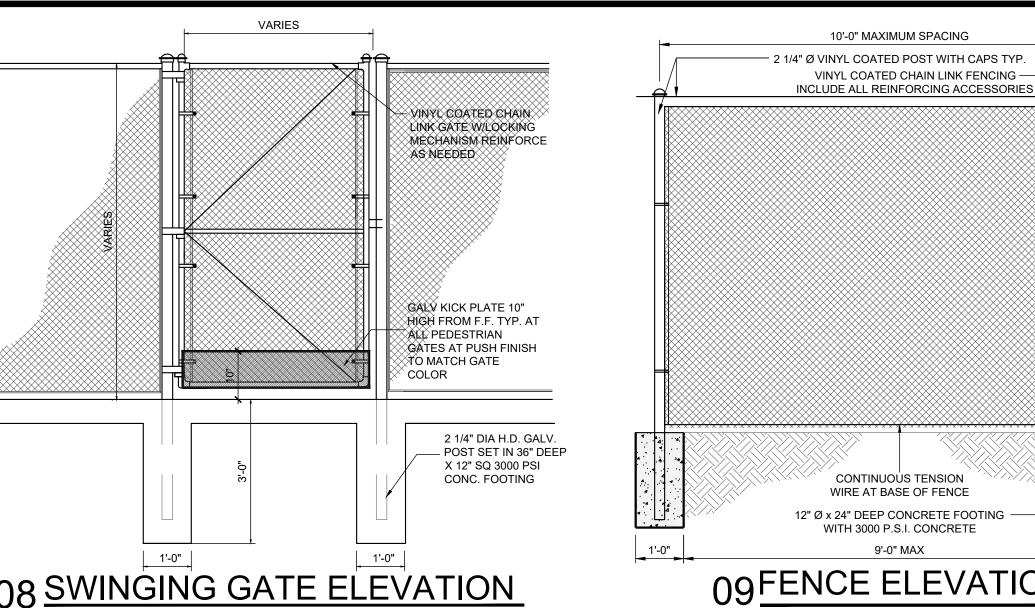


08 SWINGING GATE ELEVATION 2. ALL DIMENSIONS ARE CONSIDERED TRUE AND REFLECT MANUFACTURER'S SPECIFICATIONS. SCALE: 1/2"=1'-0"


CONTINUOUS TENSION WIRE AT BASE OF FENCE 12" Ø x 24" DEEP CONCRETE FOOTING WITH 3000 P.S.I. CONCRETE

09 FENCE ELEVATION

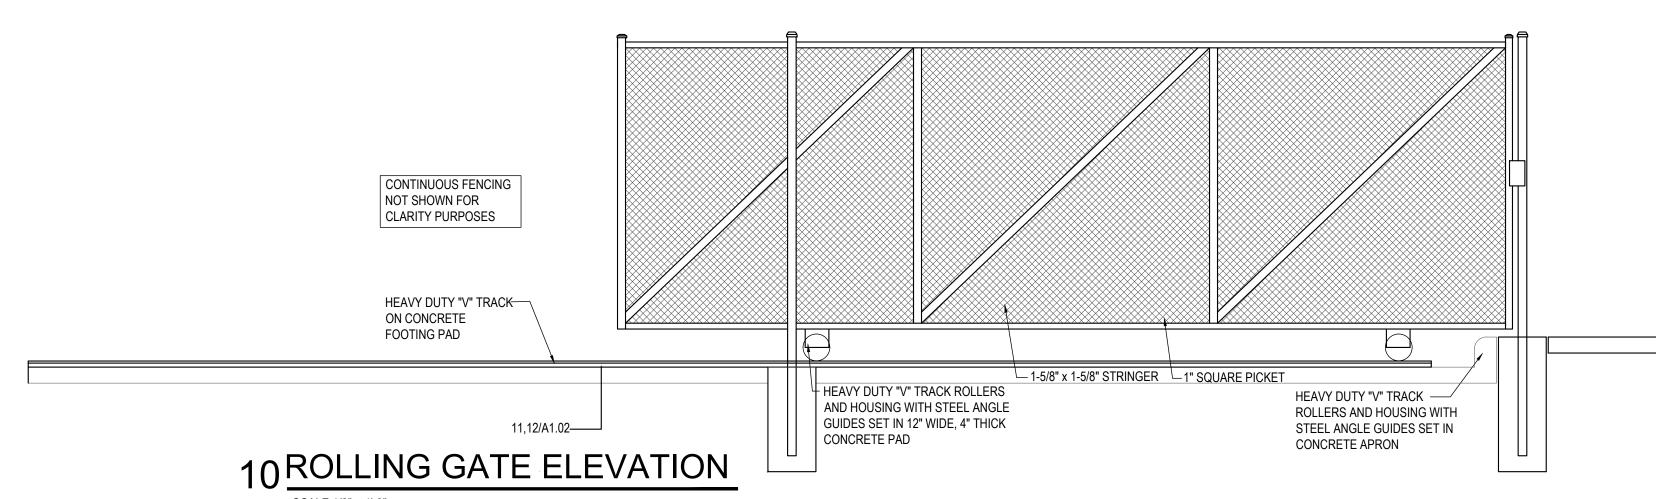

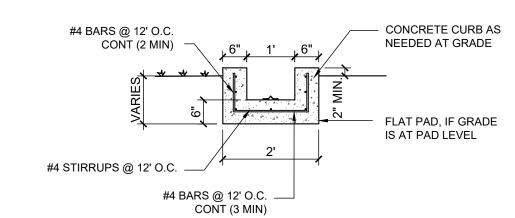

# 11 ROLLING GATE SECTION

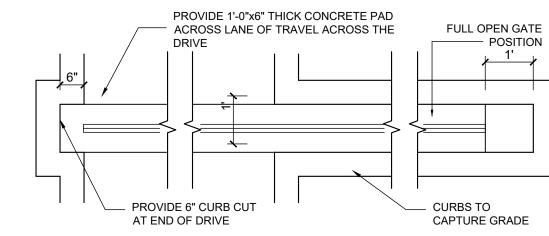

12 ROLLING GATE PAD



REVISIONS BY

GMS ARCHITECT

1150 Paredes Line Rd.

Brownsville, Texas 78526

(956) 546-0110 Fax (956) 546-0196


**OVEMENTS** 

IMPR

ARK

CAME

SANTA

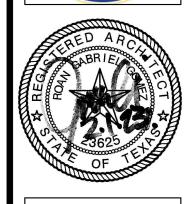

© Copyright 2023 Gomez Mendez Saenz Inc. Architects-Planners Interior Designers

As Note Project Architect: Roan G. Gomez, AIA
Drawn By: SANTA ROSA - PHASE 2
Sheet:

A1.02

GMS ARCHITECTS


1150 Paredes Line Rd.
Brownsville,
Texas 78526

(956) 546-0110 Fax (956) 546-0196

REVISIONS BY

MERON COUNTY PARKS ROSA PARK IMPROVEMENTS



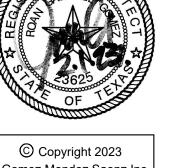

Gomez Mendez Saenz Inc.
Architects-Planners
Interior Designers

Date:

Scale:


As Noted
Project Architect:

Roan G. Gomez, AIA
Drawn By:

Job No.

SANTA ROSA - PHASE 2

Sheet:

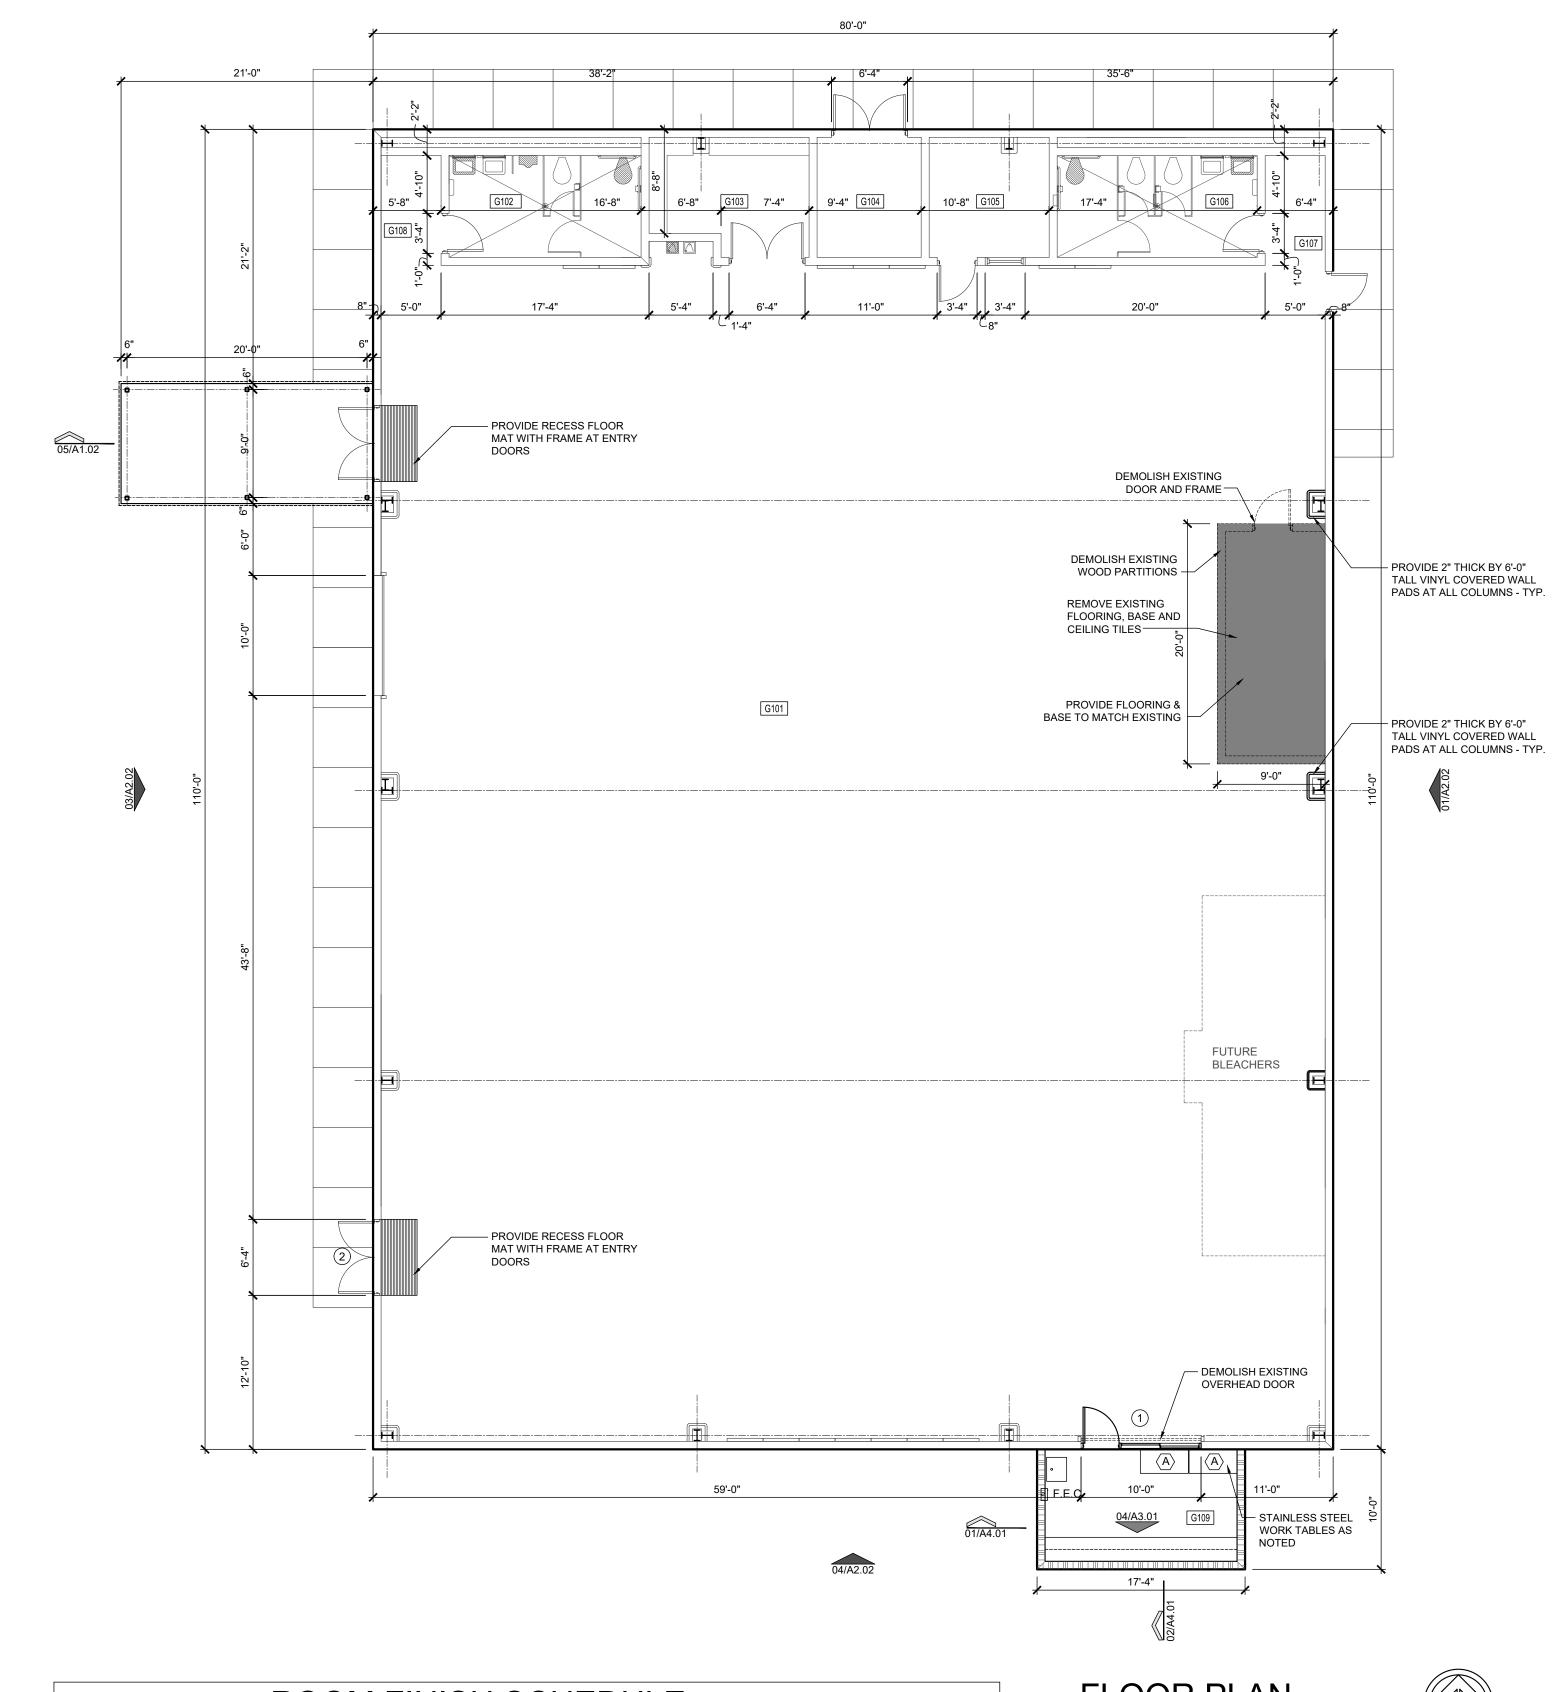

ROOM FINISH SCHEDULE										
ROOM	ROOM NAME	BASE	FLR		WAL	LS		CLG.	CLG.	REMARKS
NO.	ROOM NAME	DASE	FLK	N	S	E	W	CLG.	HEIGHTS	REWARKS
G101	GYMNASIUM	PTD	EXIST	PTD	PTD	PTD	PTD	EXIST	VARIES	3'-4" EPOXY WAINSCOT
G103	STORAGE	PTD	EXIST	PTD	PTD	PTD	PTD	EXIST	9'-0"	
G104	MECHANICAL	PTD	EXIST	PTD	PTD	PTD	PTD	EXIST		
G105	OFFICE	PTD	EXIST	PTD	PTD	PTD	PTD	EXIST	9'-0"	
G102	TOILET *	PTD	EXIST	PTD	PTD	PTD	PTD	EXIST	8'-8"	
G106	TOILET *	PTD	EXIST	PTD	PTD	PTD	PTD	EXIST	8'-8"	
G107	VESTIBULE	PTD	EXIST	PTD	PTD	PTD	PTD	EXIST	VARIES	3'-4" EPOXY WAINSCOT
G108	VESTIBULE	PTD	EXIST	PTD	PTD	PTD	PTD	EXIST	VARIES	3'-4" EPOXY WAINSCOT
G109	CONCESSION	PTD	EPOXY	PTD	CMU/PTD	CMU/PTD	CMU/PTD	SAC 1	10'-0"	3'-4" EPOXY WAINSCOT

\* WALLS TO BE PAINTED WITH EPOXY PAINT AS SPECIFIED

# <u>LEGEND</u>

EXIST EXISTING TO BE REMAIN
V.C.T VINYL COMPOSITION TILE
PTD PAINTED
CMU/PTD CONC. MASONRY UNIT PAINTED
EPOXY EPOXY FLOOR PAINT
SAC SUSPENDED ACOUSTICAL CEILING

# 1 FLOOR PLAN SCALE 1/8" = 1'-0"



### GENERAL NOTES:

1. PAINT ALL INTERIOR CONCRETE MASONRY WALLS - COLOR AS SELECTED BY ARCHITECT'S OFFICE

2. PAINT ALL EXPOSED INTERIOR STRUCTURAL STEEL FRAMING COLOR AS SELECTED BY ARCHITECT'S OFFICE

3. PROVIDE FOR BULLNOSE CMU AT ALL EXTERIOR CORNER CONDITIONS AT WALL AND SILL CONDITIONS - EXCEPT FOR FIRST CMU AT WALL BASE

4. PROVIDE FOR TWO (2) 8" HIGH ACCENT STRIPES & ONE (1) 12" HIGH PAINTED STRIPE AT GYMNASIUM.

5. PROVIDE PAINTED 'BOYS AND GIRLS CLUB LOGO' ON THE INTERIOR WALL OF ROOM G101.6. PATCH TO MATCH EXISTING FINISHES DISTURBED BY DEMOLITION WORK.

7. PROVIDE TWO (2) ADVANCE TABCO STAINLESS STEEL WORK TABLES - MS-244 TO BE LOCATED IN ROOM G109.

1150 Paredes Line Rd.
Brownsville,
Texas 78526
(956) 546-0110
Fax (956) 546-0196

REVISIONS BY

CAMERON COUNTY PARKS
NTA ROSA PARK IMPROVEMENTS





© Copyright 2023 Gomez Mendez Saenz Inc. Architects-Planners Interior Designers

Scale:

As Noted

Project Architect:

Roan G. Gomez, AIA

Drawn By:

Job No.
SANTA ROSA - PHASE 2
Sheet:


42.01

REVISIONS BY


# SA PARK IMPROVEMENTS CAMERON SANTA





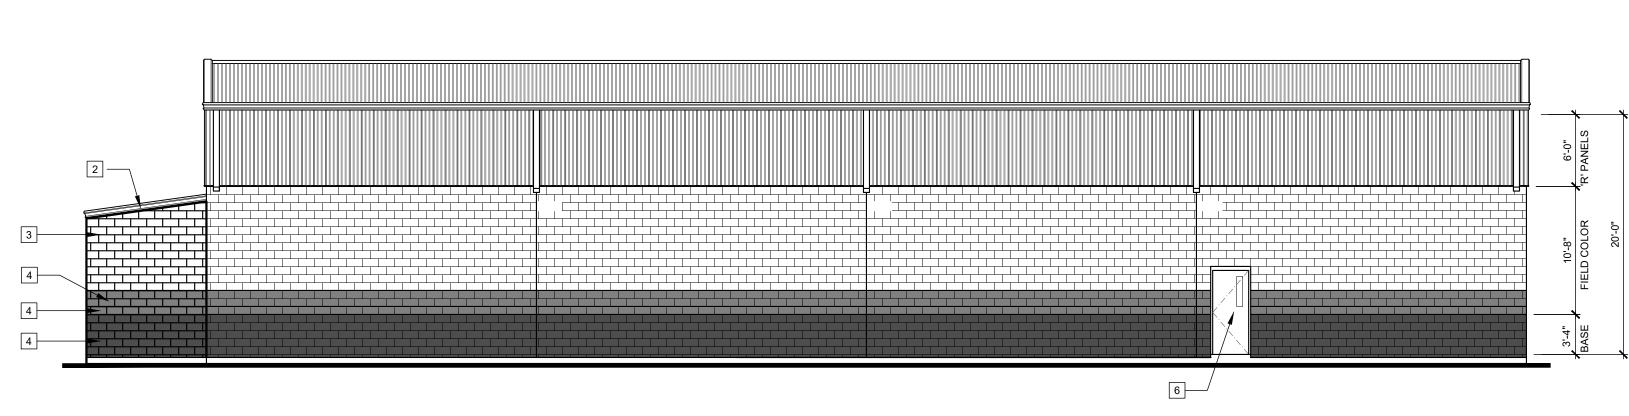


# 01 EAST BUILDING ELEVATION SCALE 1/8" = 1'-0"

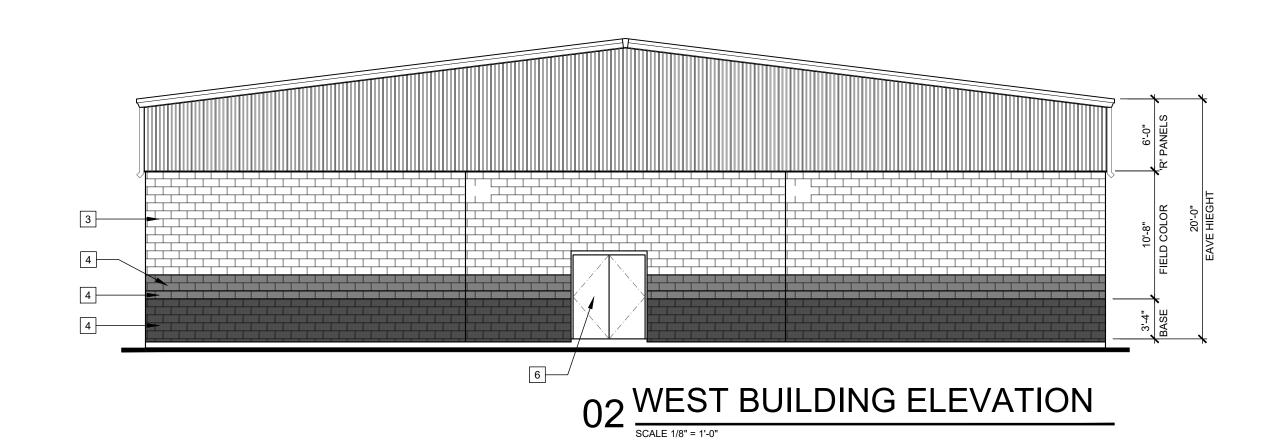




# 03 WEST BUILDING ELEVATION

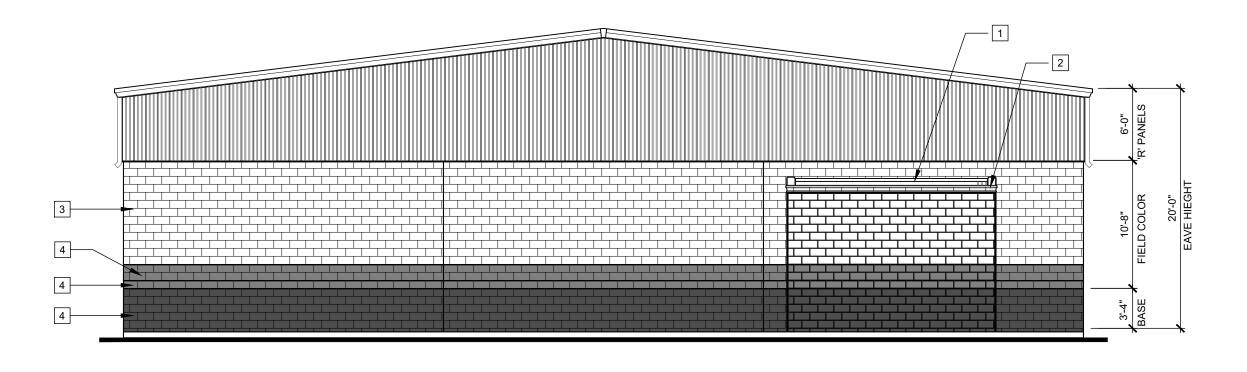

# 04 SOUTH BUILDING ELEVATION SCALE 1/8" = 1'-0"

# **KEYED NOTES**


- 1 METAL ROOF PANELS
- 2 PRE-FINISHED FASCIA, GUTTER AND DOWNSPOUTS
- 3 PAINTED CMU EXTERIOR WALL
- 4 PAINTED ACCENT STRIPES
- 5 PAINTED BOYS & GIRLS CLUB LOGO
- 6 PAINTED METAL DOOR AND FRAME
- 7 PREFINISHED METAL WALKWAY CANOPY

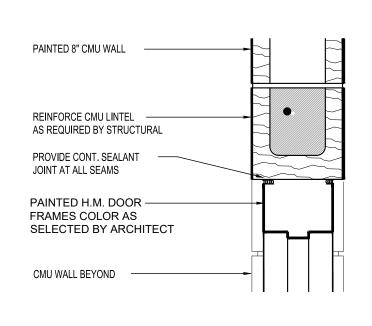

# 03 DOOR HEAD DETAIL SCALE 1-1/2" = 1'-0"

1	DOOR AS SCH'D
A J MAY 450 AV HANDICAPPED PANIC THRESHOLD	WARP CONC UP TO FIN FL WITH FLOORING AS SCHEDULED
FLOORING AS SCHEDULED	1/2" MAX.
	NC SLAB SET ON BED OF CAULKING

# 02 THRESHOLD DETAIL

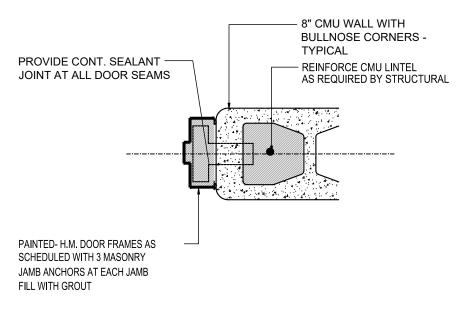


01 DOOR JAMB DETAIL

	DOOR SCHEDULE											
DOOR NO.			DOOR			FRA	AME			DET	AIL	DEMARKS
NO.	MATL	W	Н	T	MATL	W	Н	T	HDWR	JAMB	HEAD	REMARKS
1	НМ	3'-0"	7'-0"	1-3/4"	НМ	10'-0"	10'-0"	5-3/4"	Α	01/A3.01	03/A3.01	


NOTE: 1. ALL EXTERIOR DOORS TO BE HOT DIPPED GALVANIZED REGARDLESS WHETHER NOTED OR NOT NOTED (DOES NOT APPLY FOR ALUMINUM DOORS)

2. ALL EXTERIOR DOORS TO MEET HURRICANE AND HIGH IMPACT RESISTANCE REQUIREMENTS WHETHER NOTED OR NOT NOTED

3. SUBMIT TESTS FOR WIND LOAD COMPLIANCE. REFER TO STRUCTURAL NOTES FOR LOADING

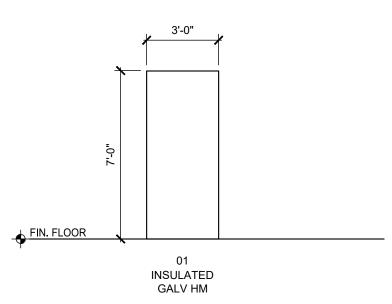


# **DOOR ELEVATIONS**

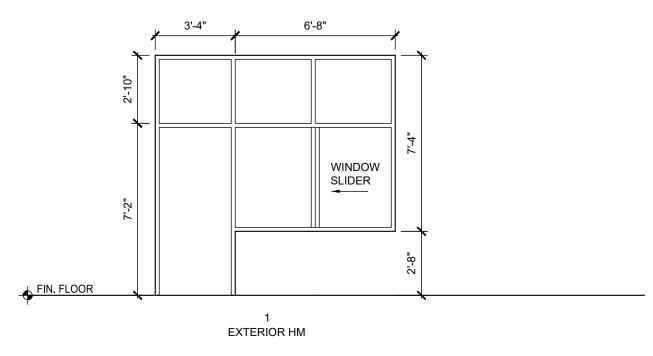



# FRAME ELEVATIONS SCALE 1/4" = 1'-0"

ALL GLAZING TO BE LAMINATED SAFETY GLASS

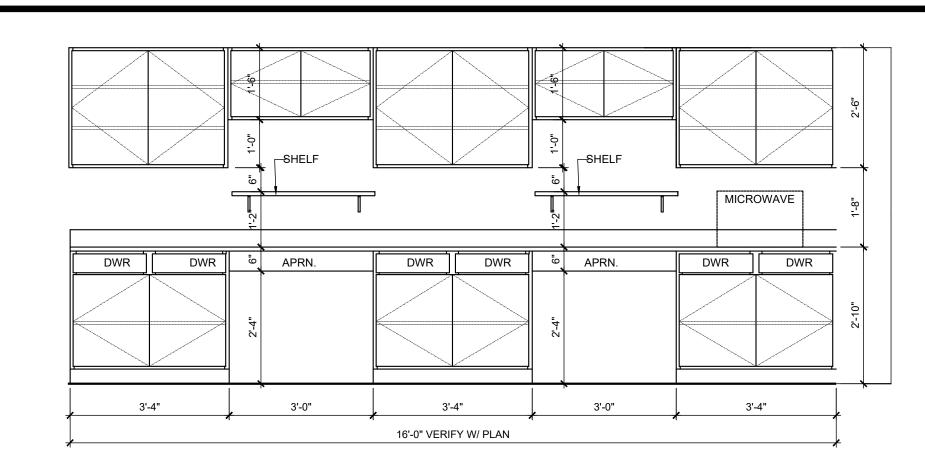

# 04 CABINET ELEVATION SCALE 1/2" = 1'-0"

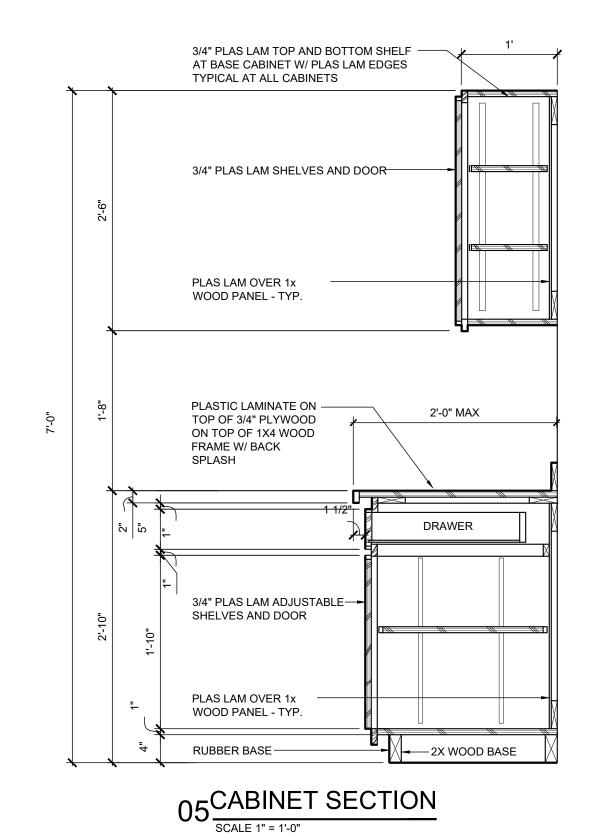

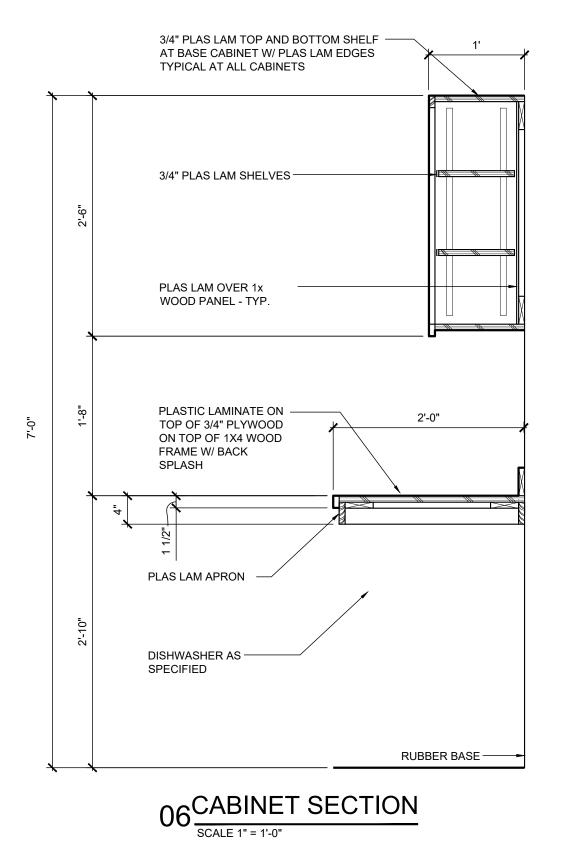

CONTY OF CON



REVISIONS BY

GMS ARCHITECT

1150 Paredes Line Rd. Brownsville, Texas 78526

(956) 546-0110 Fax (956) 546-0196

**OVEMENTS** 

**ARK IMPR** 

0

CAMER SANTA ROS

© Copyright 2023
Gomez Mendez Saenz Inc.
Architects-Planners
Interior Designers

Scale:

As Noted
Project Architect:

Roan G. Gomez, AIA
Drawn By:

RN
Job No.


SANTA ROSA - PHASE 2
Sheet:

A3.01

**GMS** ARCHITECT 1150 Paredes Line Rd. Brownsville, Texas 78526 (956) 546-0110 Fax (956) 546-0196


> VEMENT **IMPR** ARK



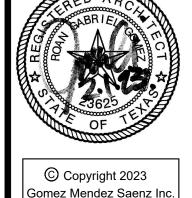


Gomez Mendez Saenz Inc Architects-Planners Interior Designers JANUARY 202

As Note Project Architect: Roan G. Gomez, AlA SANTA ROSA - PHASE 2
Sheet:

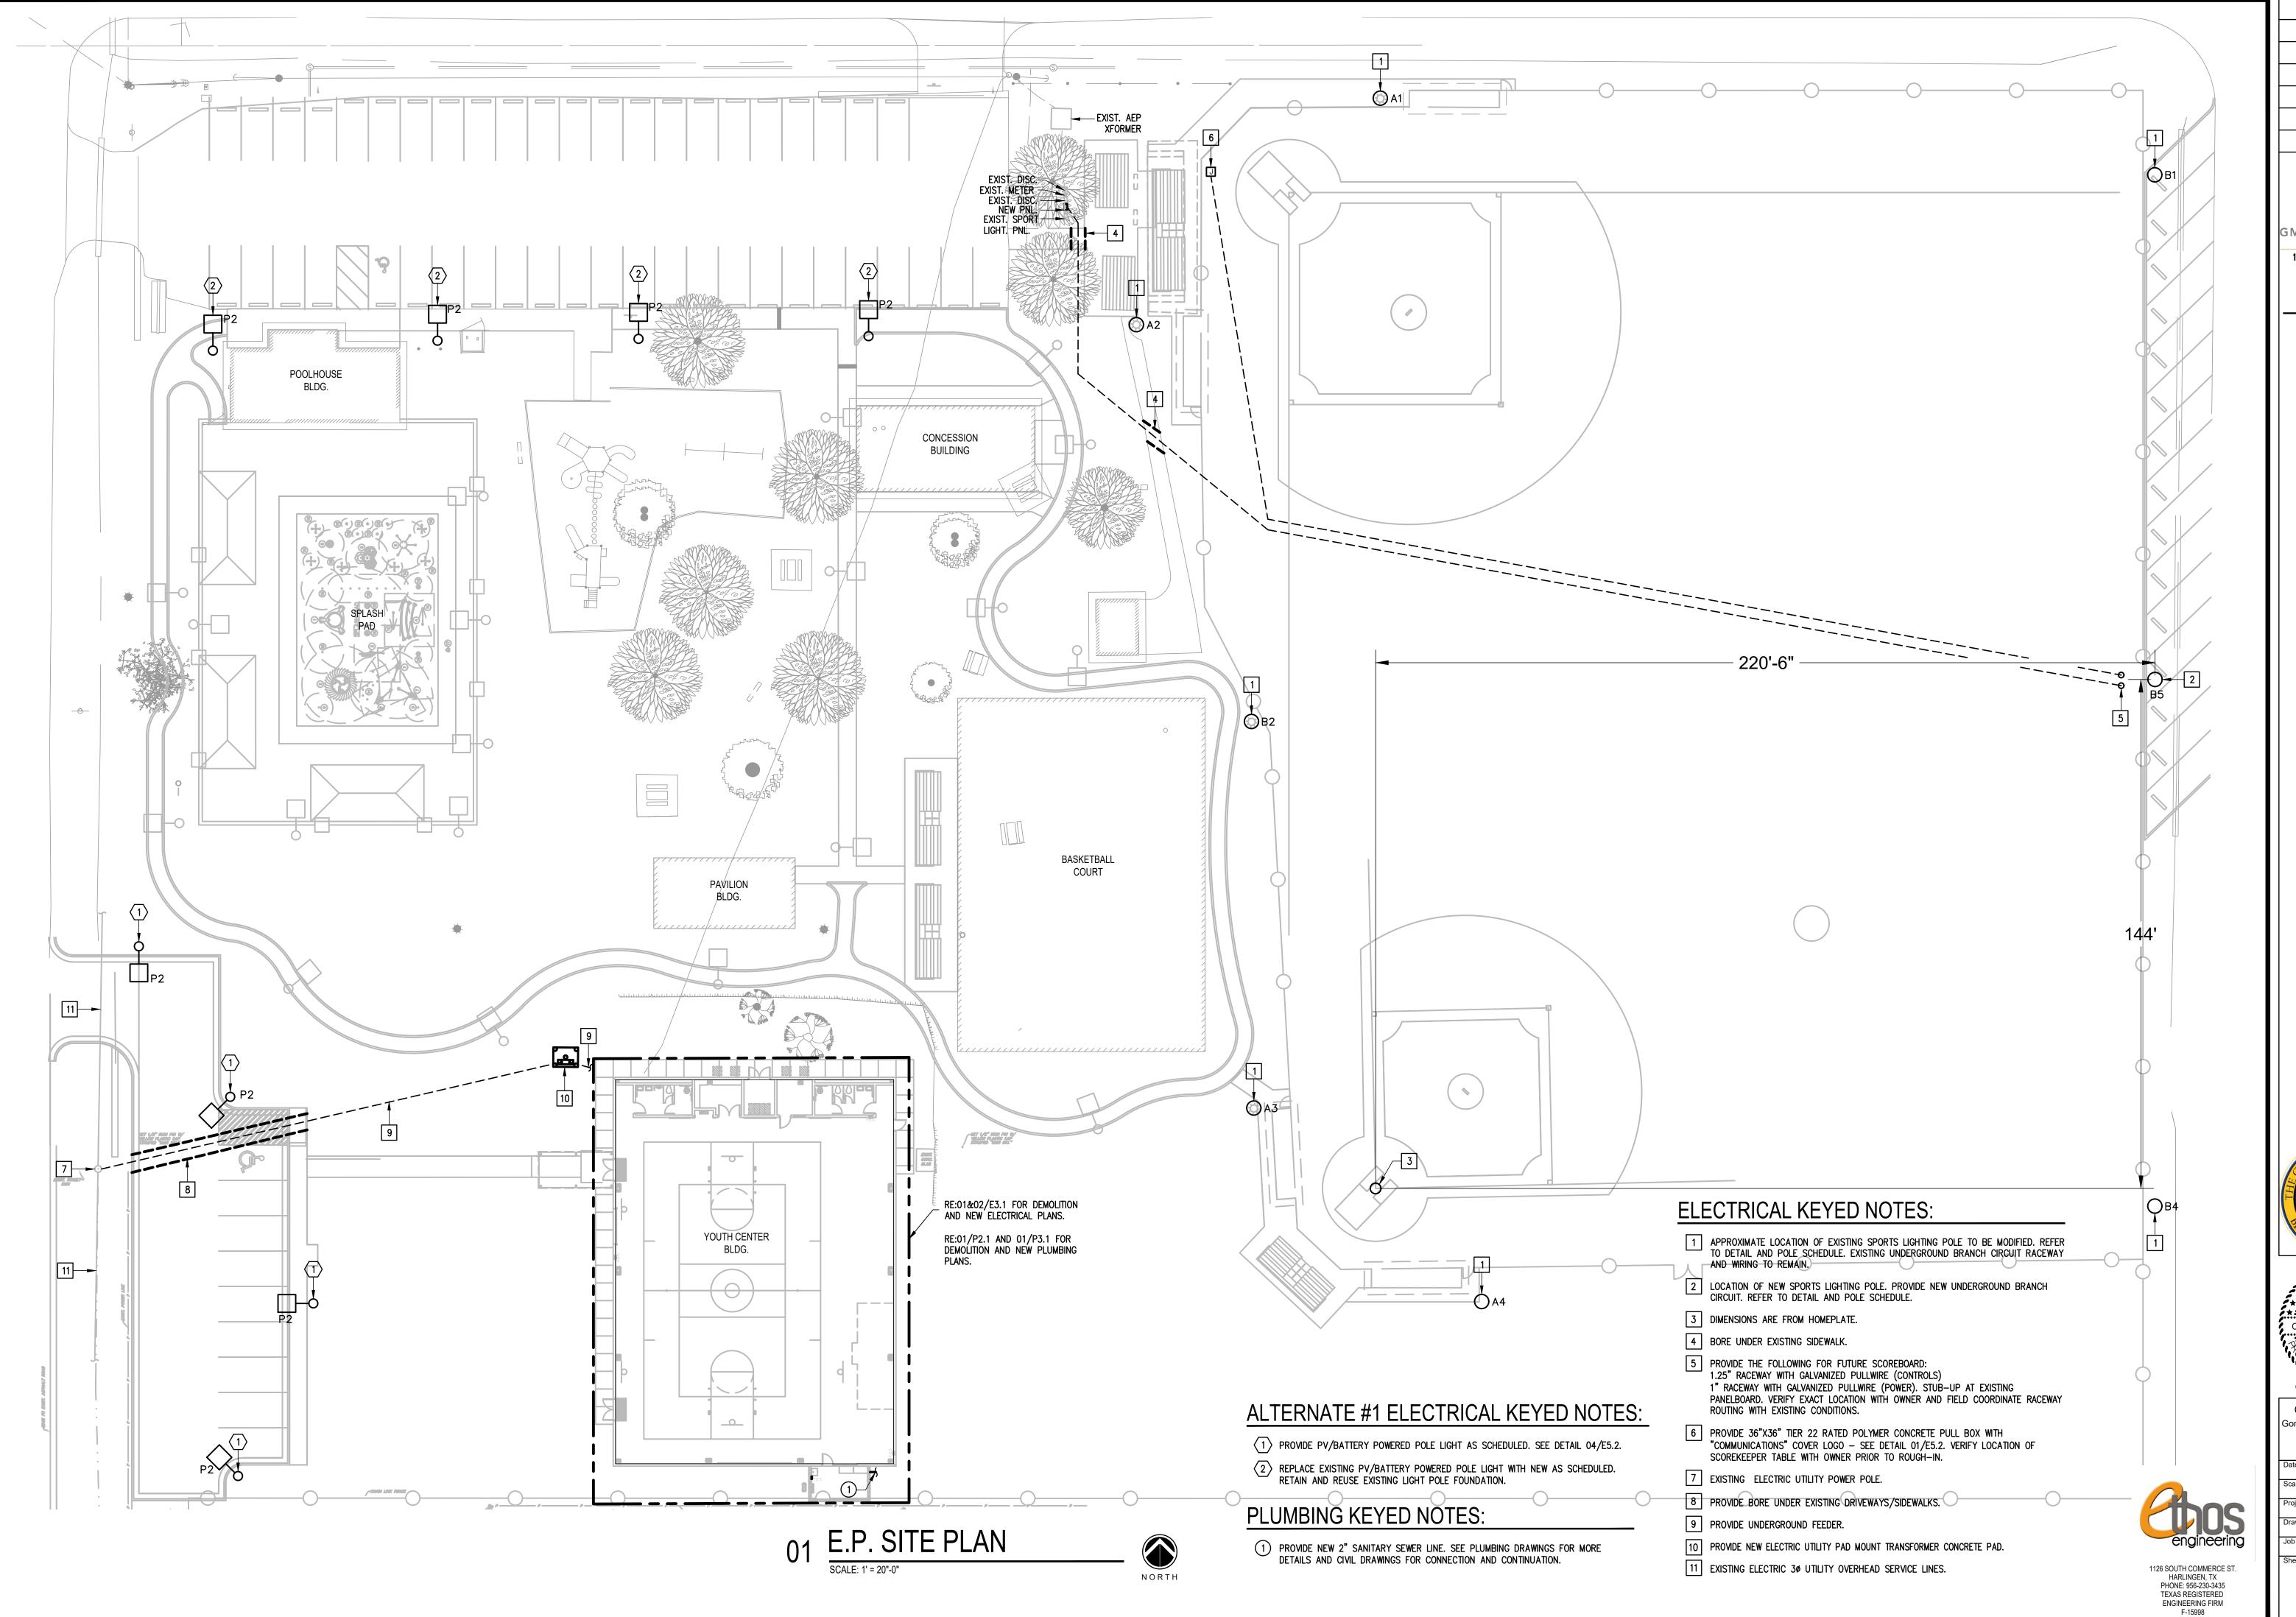





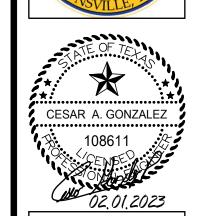

© Copyright 2022 Somez Mendez Saenz Inc. Architects-Planners

Interior Designers

# ABBREVIATIONS:

		<b>5110</b>	ENERGY MANAGEMENT GYGTEM	14000	LAN OVEROUPPENT PROTECTION
Α	AMPS	EMS	ENERGY MANAGEMENT SYSTEM	MOCP	MAX. OVERCURRENT PROTECTION
ABC	ABOVE CEILING LINE	EXT.	EXTERNAL OR EXTERIOR	NTS	NOT TO SCALE
AC	ABOVE COUNTER BACKSPLASH	FACP	FIRE ALARM CONTROL PANEL	OA	OUTSIDE AIR
ACCU	AIR COOLED CONDENSING UNIT	FCU	FAN COIL UNIT	OAU	OUTSIDE AIR UNIT
AHU	AIR HANDLING UNIT	FD	FIRE DAMPER	Р	POLE(S)
AFF	ABOVE FINISHED FLOOR	FS	FLAT SCREEN	PA	PUBLIC ADDRESS
ACB	ABOVE COUNTER BACKSPLASH	G.	GROUND	PH	PHASE
B.	ВОТТОМ	GA.	GAGE	RM.	ROOM
BLC.	BELOW CEILING LINE	GALV.	GALVANIZED	SS	STAINLESS STEEL
C.	CONDUIT OR COMMON	GRND.	GROUND	TSTAT	THERMOSTAT
CLG.	CEILING	HP	HORSEPOWER	UG	UNDERGROUND
COMB.	COMBINATION	HVAC	HEATING, VENTILATION,	UNO	UNLESS OTHERWISE NOTED
COND.	CONDUIT	HVAC	& AIR CONDITIONING	٧	VOLTS
CU.	COPPER	IG	ISOLATED GROUND	VAV	VARIABLE AIR VOLUME
DDC	DIRECT DIGITAL CONTROLS	INT.	INTRUSION DETECTION	VFD	VARIABLE FREQUENCY DRIVE
DISC.	DISCONNECT	MECH	MECHANICAL	WACU	WALL AIR CONDITIONING UNIT.
EDH	ELECTRIC DUCT HEATER	MS	MOTOR STARTER	W	WRE
EF	EXHAUST FAN				

# LIGHTING SYMBOL LEGEND:

	(SEE NOTE 1)
2'X4' LIGHT FIXTURE - TYPE AS NOTED	
EMERGENCY 2'X4' LIGHT FIXTURE—TYPE AS NOTED CONNECT BATTERY PACK TO BE ON AT ALL TIMES (UNSWITCHED)	
SURFACE/WRAPAROUND LIGHT FIXTURE	
SURFACE/WRAPAROUND EMERGENCY LIGHT FIXTURE CONNECT BATTERY PACK TO BE ON AT ALL TIMES (UNSWITCHED)	
SINGLE FACE EXIT SIGN CEILING OR WALL MOUNTING (DIRECTIONAL ARROWS WHERE INDICATED)	12" ABV. EGRESS OPENING
DOUBLE FACE EXIT SIGN CEILING OR WALL MOUNTING (DIRECTIONAL ARROWS WHERE INDICATED)	12" ABV. EGRESS OPENING
EMERGENCY LIGHTING UNIT	8'-0"AFF
WALL MOUNT LIGHT FIXTURE — TYPE AS NOTED	
HIGH BAY FIXTURE - TYPE AS NOTED	
	EMERGENCY 2'X4' LIGHT FIXTURE—TYPE AS NOTED CONNECT BATTERY PACK TO BE ON AT ALL TIMES (UNSWITCHED)  SURFACE/WRAPAROUND LIGHT FIXTURE  SURFACE/WRAPAROUND EMERGENCY LIGHT FIXTURE CONNECT BATTERY PACK TO BE ON AT ALL TIMES (UNSWITCHED)  SINGLE FACE EXIT SIGN CEILING OR WALL MOUNTING (DIRECTIONAL ARROWS WHERE INDICATED)  DOUBLE FACE EXIT SIGN CEILING OR WALL MOUNTING (DIRECTIONAL ARROWS WHERE INDICATED)  EMERGENCY LIGHTING UNIT  WALL MOUNT LIGHT FIXTURE — TYPE AS NOTED

# LIGHTING WIRING DEVICES SYMBOL LEGEND:

SYMBOL	DESCRIPTION	MNTG. HT. UNO (SEE NOTE 1)
S	SINGLE POLE TOGGLE SWITCH - HUBBELL MODEL #HBL1221W (WHITE)	48"AFF
S <sub>vs</sub>	VACANCY WALL SENSOR SWITCH — LUTRON MODEL #MS-OPS2-WH (CW-1-WH). PROVIDE 0-10V SIGNAL WIRE IN RACEWAY FROM SWITCH TO EA. CONTROLLED LIGHT FIXTURE.	48"AFF
PC	DIGITAL OUTDOOR PHOTO CELL WALL MOUNTED	

GENER	GENERAL SYMBOL LEGEND:								
SYMBOL	DESCRIPTION	MNTG. HT. UNO (SEE NOTE 1)							
_	ELECTRICAL PANELBOARD — SURFACE MOUNTED	AS REQUIRED							
	CONCEALED RACEWAY	AS REQUIRED							

LUMIN	IAIRE SCHEDUL	.E									
CALLOUT	LAMP	DESCRIPTION	DRIVER	MOUNTING	MODEL	INPUT WATTS	VOLTS	NOTE 1	LUMENS /	LUMENS MAINT.	HOURS
A2	LED	2'X4' LAY-IN INDIRECT TROFFER	0-10V	RECESSED	LITHONIA: 2BLT4 40L ADSM MVOLT GZ10 LP840 LSI: OPT24 LED FS1 4066LM UNV DIM	34	MULTIPLE		4032	L80	60,000
A2E	LED	2'X4' LAY-IN INDIRECT TROFFER	0-10V	RECESSED	LITHONIA: 2BLT4 40L ADSM MVOLT GZ10 LP840 EL14L LSI: OPT24 LED FS1 4066LM UNV DIM EM	34	MULTIPLE	PROVIDE WITH AN EMERGENCY BATTERY PACK.	4032	L80	60,000
D2	LED	4' WRAPAROUND	0-10V	SURFACE/ROD	LITHONIA: BLWP4 48L SDSM GZ10 LP840 WILLIAMS: 17-4-L55/840-AF-DIM-UNV	40	MULTIPLE		5205	L90	50,000
D2E	LED	4' WRAPAROUND	0-10V	SURFACE/ROD	LITHONIA: BLWP4 48L SDSM GZ10 LP840 E10WLCP WILLIAMS: 17-4-L55/840-AF-EM/10W-DIM-UNV	40	MULTIPLE	PROVIDE WITH AN EMERGENCY BATTERY PACK.	5205	L90	50,000
H4	LED	15" ROUND HIGH BAY	0-10V	SURFACE	AEL: LUFOHB-14-4K-PRM-BLK-UNV LITHONIA: JEBL 12L 40K 80CRI WH	100	277V 1P 2W		13961	L70	141,000
H6	LED	15" ROUND HIGH BAY	0-10V	SURFACE	AEL: LUFOHB-21-4K-PRM-BLK-UNV LITHONIA: JEBL 18L 40K 80CRI WH	150	277V 1P 2W		20799	L70	141,000
ME	LED	WALLPACK	0-10V	SURFACE	LITHONIA: WDGE2 LED P3 40K 80CRI VF MVOLT E10WH DDBXD RAYON: T630LEDB 27 UNI12 40 T3 BZ G2 EM	27	MULTIPLE	PROVIDE UL LISTED FOR WET LOCATIONS AND WITH AN EMERGENCY BATTERY PACK. PROVIDE DARK BRONZE FINISH TO MATCH EXISTING.	3000	L80	50,000
N	LED	WALLPACK	0-10V	SURFACE	LITHONIA: WDGE2 LED P4 40K 80CRI VF MVOLT DDBXD RAYON: T630LEDB 45 UNI12 40 T3 BZ G2	50	MULTIPLE	PROVIDE UL LISTED FOR WET LOCATIONS. PROVIDE DARK BRONZE FINISH TO MATCH EXISTING.	6000	L80	50,000
P2	LED	LED SOLAR AREA LIGHT		POLE	ROMANSO: RMS-H210480 POLE: ENERGY LIGHT INC H18A5RS125 39" X 20.47" X 12.48"	80	MULTIPLE	PROVIDE FIXTURE UL LISTED FOR WET LOCATIONS AND WITH A MOTION SENSOR & TIME CONTROLLER TOGETHER. POLE SHALL BE 18' ROUND STRAIGHT ALUMINUM & RATED FOR 138MPH WINDS. PROVIDE POLE WITH A VIBRATION DAMPER. STANDARD COLOR FINISH TO BE SELECTED AT A LATER DATE.COLOR TEMPERATURE 57K.5 YEARS OF WARRANTY.	13600	LM-70	50,000
S	LED	WRAPAROUND	0-10V	SURFACE	VENTURE: VP4-40NA-BF1	50	277V 1P 2W	PROVIDE UL LISTED FOR DAMP LOCATIONS	6318	L70	60,000

**GENERAL NOTES:** 

BEGHELLI: BS101LED 4 HT LO WT40 120-277V SS TPS

3.EMERGENCY BATTERY PACKS SHALL BE COMPLETE FACTORY INSTALLED WITH NI-CAD BATTERY, CHARGER INDICATING LIGHT, ELECTRONIC CIRCUITRY, 1400 LUMENS OUTPUT, 90 MINUTES DURATION & FIVE FULL YEARS WARRANTY.







TYPE ME,N



TYPE D2,D2E



TYPE S



TYPE H4,H6


AND PROVIDE CORNER MOUNT BRACKET. PROVIDE LIGHT GRAY FINISH TO MATCH



TYPE P2




CAMER ROSA PA

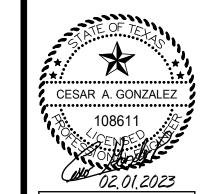

© Copyright 2022 Gomez Mendez Saenz Ind Architects-Planners Interior Designers

1126 SOUTH COMMERCE ST. HARLINGEN, TX PHONE: 956-230-3435 TEXAS REGISTERED ENGINEERING FIRM F-15998

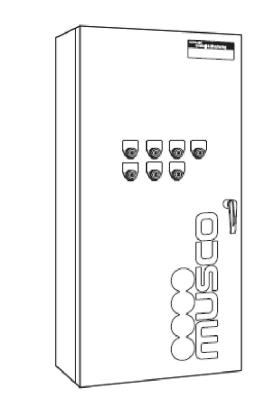

MUSCO CONTROL-LINK 07 CONTACTOR CABINET IMAGE

REVISIONS BY

1150 Paredes Line Rd.

(956) 546-0110 Fax (956) 546-0196

<sup>1.)</sup> REFERENCE LIGHT FIXTURE SCHEDULE FOR ALL MOUNTING HEIGHTS.

NOTES:

1.) 48" AFF INDICATES TO TOP OF DEVICE;
ALL OTHER MOUNTING HEIGHTS REFER TO CENTERLINE OF DEVICE.

<sup>1.</sup>OTHER LIGHT FIXTURE MANUFACTURERS THAN THOSE LISTED ON THIS SCHEDULE ARE REQUIRED TO OBTAIN PRIOR APPROVAL BY SUBMITTING CUT SHEETS OF THEIR SUBSTITUTIONS AT LEAST (10) DAYS PRIOR TO BID. CUT SHEETS SHALL INDICATE/HIGHLIGHT PHOTOMETRIC CURVE, EFFICIENCY & CONSTRUCTION FOR DIRECT COMPARISON WITH SPECIFIED FIXTURES.

2.EXTRA MATERIALS: SEE SPECIFICATIONS.

02 GYMNASIUM LIGHTING & ELECTRICAL PLAN

01 GYMNASIUM DEMOLITION PLAN

## **DEMOLITION GENERAL NOTES:**

1. REFER TO ARCHITECTURAL SPECIFICATIONS FOR PHASING REQUIREMENTS.

REVISIONS BY

GMS ARCHITECTS

1150 Paredes Line Rd.

Brownsville, Texas 78526 (956) 546-0110

Fax (956) 546-0196

S

MER SA P

- 2. THE EXTENT OF DEMOLITION WORK IS INDICATED ON THE ARCHITECTURAL DRAWINGS AND BY THE REQUIREMENTS OF THIS SECTION. A VISIT TO THE SITE IS REQUIRED TO PROPERLY BID THE DEMOLITION WORK.
- 3. REMOVED MATERIALS SHALL BELONG TO OWNER. DELIVER THEM TO OWNERS DESIGNATED LOCATION. IF OWNER DOES NOT WANT THE REMOVED MATERIALS THEN REMOVE THEM FROM SITE & PROPERLY DISPOSE OF
- 4. IF REMOVAL OF EXISTING ELECTRICAL SYSTEMS RENDERS EXISTING ELECTRICAL SYSTEMS DOWNSTREAM TO REMAIN INOPERABLE, PROVIDE J-BOXES, CONDUIT WIRING AND SPLICES ABOVE ACCESSIBLE CEILINGS IN ORDER TO CONTINUE OPERATION.
- 5. REFER TO ARCHITECTURAL DEMOLITION DRAWINGS FOR WALL AND CEILINGS TO BE REMOVED.
- 6. ITEMS DESIGNATED WITH AN "EX" ARE EXISTING TO REMAIN AS IS.
- PRIOR TO DEMOLITION, IN CEILINGS SCHEDULED TO BE REMOVED AND (OR) REPLACED FOR NEW WORK, PREPARE REFLECTED CEILING PLAN SKETCH SHOWING LOCATIONS OF ALL CEILING COMPONENTS AND DEVICES TO BE RE-USED INCLUDING BUT NOT LIMITED TO: LIGHT FIXTURES
- WIRELESS ACCESS POINTS • FIRE ALARM DEVICES

SPEAKERS

- IF ANY OF THE ABOVE ITEMS ARE IN NON-WORKING CONDITION, SUBMIT A WRITTEN REPORT TO OWNER/ARCHITECT. TEMPORARY SUPPORT AND OR REMOVAL OF THESE SYSTEMS SHALL BE PROVIDED FOR NEW WORK.
- 8. PROVIDE BLANK COVERPLATE FOR UNUSED BACKBOXES.

### **DEMOLITION KEYED NOTES:**

- 1) DISCONNECT AND REMOVE EXISTING HIGH BAY LIGHT FIXTURE TO BE REPLACED - TYPICAL.
- 2) DISCONNECT AND REMOVE EXISTING SUSPENDED LINEAR LIGHT FIXTURE TO BE REPLACED TYPICAL.
- 3) DISCONNECT AND REMOVE EXISTING TROFFER LIGHT FIXTURE TO BE REPLACED - TYPICAL.
- 4) DISCONNECT AND REMOVE EXISTING WALL MOUNTED LINEAR LIGHT FIXTURE TO BE REPLACED.
- 5 DISCONNECT AND REMOVE EXISTING WALL MOUNTED EXTERIOR LIGHT FIXTURE TO BE REPLACED - TYPICAL.
- (6) EXISTING EMERGENCY LIGHT FIXTURE TO REMAIN AS IS TYPICAL.
- (7) EXISTING EXIST SIGN FIXTURE TO REMAIN AS IS TYPICAL.
- (8) EXISTING PHOTOCELL TO REMAIN AS IS.
- 9) DISCONNECT AND REMOVE OVERHEAD DOOR CONTACT ALONG WITH RELATED RACEWAY, WIRING AND SUPPORT HARDWARE.
- (10) APPROXIMATE LOCATION OF EXISTING FIRE LITE ALARMS BY HONEYWELL MODEL "MS-9050UD" ADDRESSABLE FIRE ALARM CONTROL PANEL.
- 11) DISCONNECT AND REMOVE ANY AND ALL LIGHTING, ELECTRICAL AND SPECIAL SYSTEMS ALONG WITH RELATED RACEWAYS, WIRING AND SUPPORT HARDWARE LOCATED ON WALLS TO BE REMOVED - TYPICAL.
- 12 DISCONNECT AND REMOVE EXISTING CEILING MOUNTED LIGHT FOR

# **GENERAL NOTES:**

- 1. LIGHTING BRANCH CIRCUIT HOMERUNS SHALL BE 3/4" 2#12 & #12G. 20A/120V HOMERUNS EXCEEDING 200FT THE WIRE SIZE SHALL BE #10 & #8 FOR 275'.
- 2. INTERIOR LIGHTING CONTROLS ARE EXISTING TO REMAIN.
- 3. EXTERIOR LIGHTING CONTROLS SHALL BE BY EXISTING PHOTOCELL.
- 4. EACH 20A/1P BRANCH CIRCUIT SHALL HAVE A DEDICATED
- 5. IF NEW DEVICES ARE TO BE INSTALLED ON EXISTING WALLS; PROVIDE SURFACE MOUNTED METAL RACEWAYS AND BOXES (WIREMOLD).

# **KEYED NOTES:**

- 1 CONNECT EMERGENCY BATTERY PACK TO BE CHARGING AT ALL TIMES (UNSWITCHED). LIGHT FIXTURE SHALL BE OPERATED BY THE CORRESPONDING SWITCH TYPICAL.
- PROVIDE NEW UNSWITCHED HOT WIRE FROM EXISTING LIGHTING CIRCUIT FOR INTEGRAL EMERGENCY BATTERY.
- 3 CONNECT TO AN EXISTING ROOM CIRCUIT TYPICAL.
- 4 PROVIDE NEW LIGHT FIXTURE TYPE "H4".
- 5 PROVIDE UNDERGROUND FEEDER.
- 6 BORE UNDER EXISTING SIDEWALK.





1126 SOUTH COMMERCE ST. HARLINGEN, TX PHONE: 956-230-3435 TEXAS REGISTERED ENGINEERING FIRM

© Copyright 2022

Gomez Mendez Saenz Inc Architects-Planners Interior Designers FEBRUARY 01, 2022

CESAR A. GONZALEZ


DISC. "MS"

YOUTH CENTER

ELECTRICAL RISER DIAGRAM

1 -

FLOOR LINE

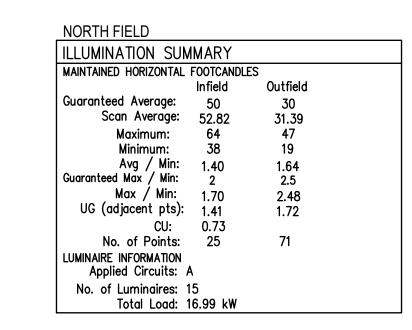

ILLUMINATION SUN	MARY		
MAINTAINED HORIZONTAL		LES	
	Infield	Outfield	
Guaranteed Average:	50	30	
Scan Average:	50.27	32.56	
Maximum:	64	47	
Minimum:	40	20	
Avg / Min:	1.25	1.67	
Guaranteed Max / Min:	2	2.5	
Max / Min:	1.60	2.42	
UG (adjacent pts):	1.26	1.58	
CU:	0.73		
No. of Points:	25	67	
LUMINAIRE INFORMATION Applied Circuits: I	3		
No. of Luminaires: Total Load:			

# **EQUIPMENT CONNECTION SCHEDULE:**

DESIGN	HP/KW	FLA	MCA	MOCP	VOLTAGE	DISCONNECT	BRANCH CIRCUIT (75°C COPPER)			
  IEWH-1	13 KW	62.5	_	80	208V/1PHASE	5) CIRCUIT BREAKER.	1.25" - 2#4 & #8G			
1) PROVIDE LOCK SAFE CIRCUIT BREAKER PER NEC 110.25.										

SIZING METHOD: COPPER 75°C

AIC 22,000

CIRCUIT DESCRIPTION

EXISTING LOAD

**EXISTING LOAD** 

EXISTING LOAD

20/3 EXISTING LOAD

SPACE

**SPACE** 

SPACE

SPACE

**SPACE** 

SPACE

SPACE

SPACE

MAIN BKR MLO

LUGS STANDARD

# FEEDER SCHEDULE:

FEEDER AMPS	CONDUIT AND FEEDER	FEEDING THESE DEVICES			
400	4" - 4#600KCMIL	METER			
400	4" - 4#600KCMIL & #3G	A, DISC. MS			

LOAD KVA

2.91 | 2.91 | 2.91

CALC KVA

10.9

13.1 A

AB

I. EXISTING SPORTS LIGHTING POLE

2. NEW SPORTS LIGHTING POLE.

DESIG	POLE	MOUNTING	NO. OF	NO. OF	NO. OF	NO. OF	NOTES	CONTACTOR I.D.
	HT.	нт.	FIXTURES "SL1"	FIXTURES "SL2"	FIXTURES "SL3"	DRIVERS		/AMPS/ZONE
SOFTBA	LL FIELD							
A1	60 FT	60 FT	2	1	_	3	1	C1/30/1
A2	60 FT	60 FT	2	1	_	3	1	C2/30/1
		60 FT	_	1	_	1	1	C9/30/3
A3	60 FT	60 FT	2	1	_	3	1	C5/30/2
A4	60 FT	60 FT	2	1	_	3	1	C6/30/2
B1	70 FT	70 FT	5	_	_	5	1	C3/30/1
B2	70 FT	70 FT	4	_	_	4	1	C4/30/1
		70 FT	3	_	1	4	1	C7/30/2
B4	70 FT	70 FT	5	_	_	5	1	C8/30/2
B5	70 FT	70 FT	5	_	_	5	2	C10/30/4


# POLE CONNECTION SCHEDULE:


B5	10.5	20	480V/3PH	450	2.15	1" - 3#10 & #10G
POLE ID	FLA	ОСР	VOLTAGE/PHASE	APPROX. DIST. (FT)	%VD	BRANCH CIRCUIT

**GENERAL NOTES:** 

- 1. FEEDER DISTANCES ARE FOR VOLTAGE DROP CALCULATIONS ONLY, NOT FOR BIDDING PURPOSES. 2. DON'T SPLICE WIRING BELOW GRADE. PROVIDE ABOVE GRADE CAST ALUMINUM BOXES AT POLE BASE.
- 3. PROVIDE PULLBOXES AS REQUIRED, SIZE PER NEC. PROVIDE WHERE REQUIRED FOR PULLING NEEDS.

LIGHT FIXTURE SCHEDULE								
Туре	Model	Source	Wattage	Lumens				
SL1	MUSCO: TLC-LED-1200	LED 5700K - 75 CRI	1170W	136,000				
SL2	MUSCO: TLC-LED-900	LED 5700K - 75 CRI	890W	89,600				
SL3	MUSCO: TLC-LED-600	LED 5700K - 75 CRI	580W	65,600				

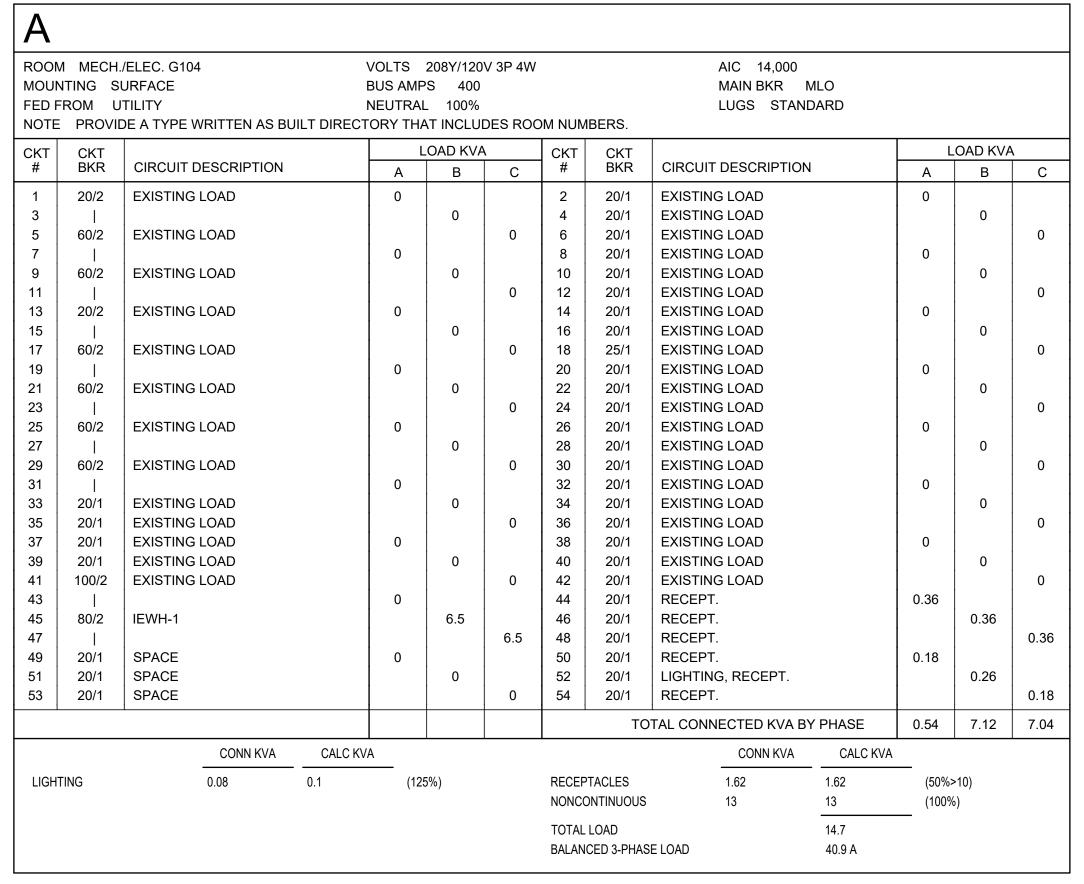

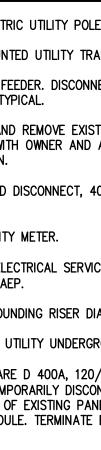

# ELECTRICAL RISER DIAGRAM **KEYED NOTES:**

1 EXISTING ELECTRIC UTILITY POLE.

LOAD KVA

2.91

PANEL

FLOOR LINE

EXISTING

125A PANEL

CKT CKT

10

18

20

22

24

40

42

TOTAL LOAD

BKR

40/3

20/3

20/2

20/1

20/1

20/1

20/1


BALANCED 3-PHASE LOAD

20/1 SPACE

- 2 NEW PAD MOUNTED UTILITY TRANSFORMER.
- PROVIDE NEW FEEDER. DISCONNECT AND REMOVE EXITING. REFER TO FEEDER SCHEDULE TYPICAL.

TOTAL CONNECTED KVA BY PHASE

- 4 DISCONNECT AND REMOVE EXISTING SERVICE DISCONNECT FOR REPLACEMENT. COORDINATE WITH OWNER AND AEP FOR TEMPORARY SERVICE
- 5 PROVIDE FUSED DISCONNECT, 400A, 3P3F, 400AF, S/N, NEMA 3R
- 6 ELECTRIC UTILITY METER.
- COORDINATE ELECTRICAL SERVICE UPGRADE TO A 120/208V, 36, 4-WIRE SYSTEM WITH AEP.
- 8 REFER TO GROUNDING RISER DIAGRAM.
- NEW ELECTRIC UTILITY UNDERGROUNG SECONDARY.
- EXISTING SQUARE D 400A, 120/240V, 1¢, 3-WIRE PANELBOARD "A" TO BE REPLACED. TEMPORARILY DISCONNECT FEEDER AND BRANCH CIRCUITS FOR THE REMOVAL OF EXISTING PANELBOARD. PROVIDE NEW PANEL AND FEEDER AS PER SCHEDULE. TERMINATE EXISTING TO REMAIN BRANCH CIRCUITS TO
- 11 EXISTING EATON 125A PANELBOARD TO REMAIN.
- PROVIDE NEW #1/0 GROUNDING ELECTRODE CONDUCTOR IN 3/4" RACEWAY

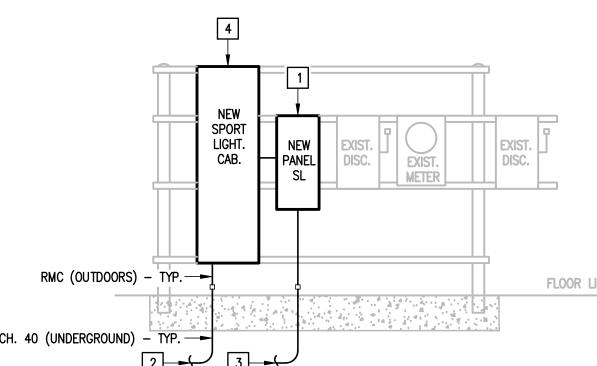

EXTERIOR ELECTRICAL RACK

ELECTRICAL RISER DIAGRAM

# ELECTRICAL RISER DIAGRAM **KEYED NOTES:**

- 1 EXISTING EATON 225A, 480/277V, 3\(\phi\), 4-WIRE, N3R PANELBOARD TO BE REPLACED. TEMPORARILY DISCONNECT FEEDER AND BRANCH CIRCUITS FOR THE REMOVAL OF EXISTING PANELBOARD. PROVIDE NEW PANEL AS PER SCHEDULE. TERMINATE FEEDER AND BRANCH CIRCUITS TO NEW PANEL.
- 2 PROVIDE SPORTS LIGHTING BRANCH CIRCUIT TO NEW POLE "B5". SEE SITE PLAN AND
- 3 PROVIDE FUTURE SCOREBOARD RACEWAY WITH GALVANIZED PULLWIRE. SEE SITE PLAN.
- 4 EXISTING SPORTS LIGHTING CONTROL CABINET TO BE REPLACED. TEMPORARILY DISCONNECT BRANCH CIRCUITS FOR THE REMOVAL OF EXISTING CABINET. PROVIDE NEW AS PER SCHEDULE. TERMINATE SPORTS LIGHTING BRANCH CIRCUITS TO NEW SPORTS LIGHTING CONTROL CABINET.



PHONE: 956-230-3435 TEXAS REGISTERED ENGINEERING FIRM

0 

REVISIONS

GMS ARCHITECT

1150 Paredes Line Rd Brownsville, Texas 78526

(956) 546-0110

Fax (956) 546-0196


S



© Copyright 2022 Somez Mendez Saenz Ind Architects-Planners Interior Designers FEBRUARY 01, 2022



- 1. INSTALL ALL ROUGH-INS IN STRICT ACCORDANCE WITH MANUFACTURER PUBLISHED TEMPLATES. PROVIDE MOCK-UP FOR OWNER REPRESENTATIVE APPROVAL.
- 2. TEMPLATE TO BE PROVIDED BY PROJECTOR MANUFACTURER/OWNER. COORDINATE WITH OWNER PRIOR TO ANY ROUGH-IN.
- 3. ROUGH-INS ARE LOCATED ON LEFT OR RIGHT HAND SIDE OF MARKER BOARD. REFER TO ELECTRICAL DRAWINGS FOR LOCATIONS. PROVIDE A DATA CONNECTOR AND CAT6 WIRING AT PROJECTOR MOUNT.

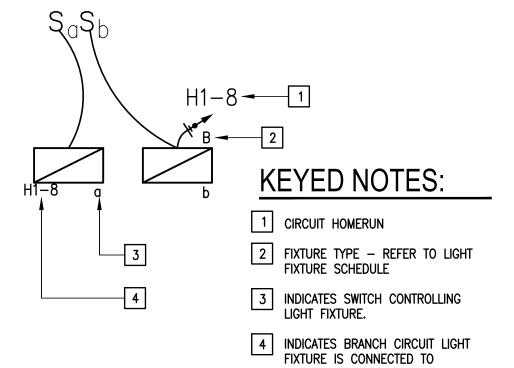


LIGHTING LEGEND DETAIL

# **KEYED NOTES:**

- 1 PROVIDE 2'x 4' LAY-IN LED FIXTURE
- 2 SUSPENDED CEILING
- PROVIDE TIE WIRE, CONNECT TO ALL FOUR CORNERS OF FIXTURE TO STRUCTURE ABOVE, INDEPENDENT OF CEILING SUPPORTS. ALL TIE WIRES TO BE PAINTED ORANGE OR OTHER EFFECTIVE MEANS OF IDENTIFICATION SO OTHER TRADES CANT BE ATTACHED TO IT.

**TYPICAL** LAY-IN FIXTURE SUPPORT S C A L E : NOT TO SCALE

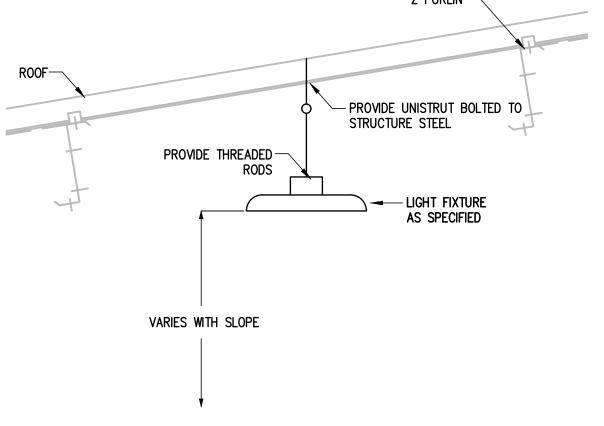

GYMNASIUM LIGHT FIXTURE MOUNTING DETAIL 05 scale: NOT TO SCALE




1126 SOUTH COMMERCE ST. HARLINGEN, TX PHONE: 956-230-3435 TEXAS REGISTERED ENGINEERING FIRM F-15998

GMS ARCHITECTS


1150 Paredes Line Rd Brownsville, Texas 78526 Fax (956) 546-0196

**REVISIONS** 


MER SA P

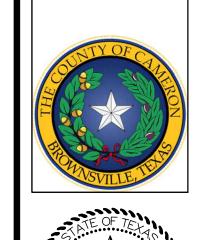

CESAR A. GONZALEZ

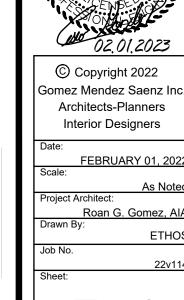

REVISIONS BY

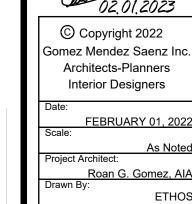

CESAR A. GONZALEZ


1126 SOUTH COMMERCE ST. HARLINGEN, TX PHONE: 956-230-3435 TEXAS REGISTERED ENGINEERING FIRM F-15998

**KEYED NOTES:** 

PROVIDE POLYMER CONCRETE PULL BOX TIER 22 RATED. COMPLYING WITH ANSI/SCTE 77 AND NEC 314.30.

2 PROVIDE 8" OF GRAVEL OR CRUSHED ROCK.

PROVIDE ONE PIECE LOCKING COVER WITH LOGO TIER 22 RATED. INSTALL COVER LEVEL WITH GRADE.

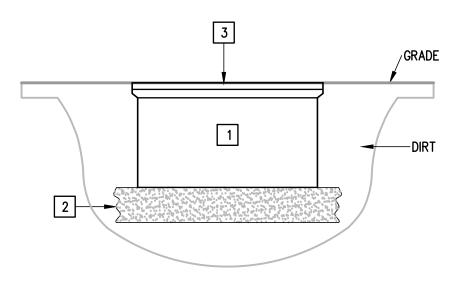



POLYMER CONCRETE 01 PULLBOX DETAIL
SCALE: NONE

CLEAR TRENCH OF ALL ROCKS AND DEBRIS BEFORE ADDING SAND CUSHION.


COMPACT TRENCH FILL TO 90% PROCTOR DENSITY IN 6" LIFTS. MAINTAIN A MINIMUM OF 60 INCHES UNDISTURBED EARTH BETWEEN PARALLEL WATER AND SEWER LINES OR SUPPORT WATER LINE ON SEPARATE SHELF A MINIMUM OF 12" ABOVE SEWER LINE.

MAINTAIN A MINIMUM OF 24" HORIZONTALLY BETWEEN ELECTRICAL PRIMARY AND SEWER. MAINTAIN A MINIMUM OF 12" VERTICALLY OR 24" HORIZONTALLY BETWEEN ELECTRICAL PRIMARY AND WATER LINES, GAS LINES, TELEPHONE RACEWAYS AND CABLE RACEWAYS.

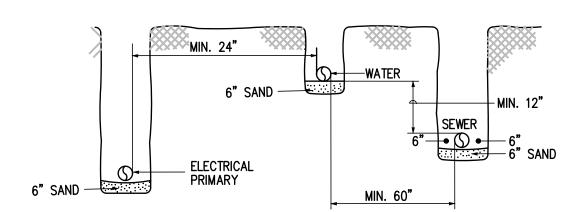

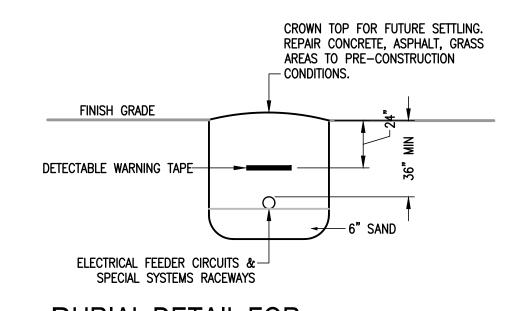


BURIAL DETAIL FOR 02 ELECTRICAL RACEWAYS

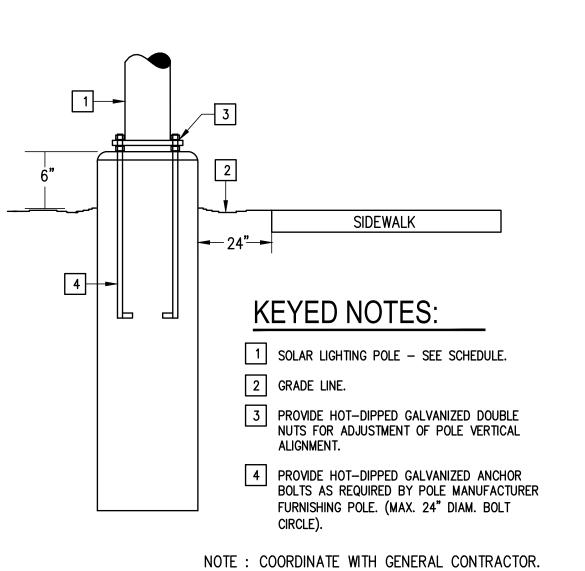

SOLAR LIGHT POLE 04 FOUNDATION DETAIL S C A L E : NOT TO SCALE

CONCESSION DEMOLITION PLAN

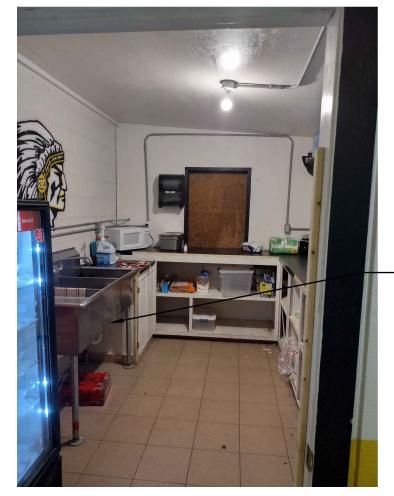





**EXISTING** 

REMOVED.

03 EXISTING CONDITIONS SCALE: NOT TO SCALE



**EXISTING CONDITIONS** 

# **DEMOLITION GENERAL NOTES:**

- 1. ALL DEMOLITION WORK SHALL BE DONE IN ACCORDANCE WITH ALL APPLICABLE CODES INCLUDING THOSE PUBLISHED BY OSHA.
- 2. THE EXTENT OF DEMOLITION WIRK IS INDICATED ON THE ARCHITECTURAL DRAWINGS AND BY THE REQUIREMENTS OF THIS SECTION. A VISIT TO THE SITE IS REQUIRED TO PROPERLY BID THE DEMOLITION WORK.
- 3. PROVIDE ALL DEMOLITION WORK REQUIRED FOR THE REMOVAL OF EXISTING NON REUSED PLUMBING EQUIPMENT AND ASSOCIATED DEVICES. PROVIDE A COMPLETE AND OPERABLE SYSTEM UPON COMPLETION OF THE PROJECT.
- 4. COORDINATE DEMOLITION OF DIVISION 22 SYSTEM AS REQUIRED WITH ALL OTHER TRADES.
- 5. ALL EXISTING EQUIPMENT REMOVED DURING CONSTRUCTION, THAT IS NOT TO BE REUSED, SHALL BE REMOVED FROM THE JOB SITE AND PROPERLY RETURNED TO THE OWNER, IF DESIRED BY OWNER.
- 6. IT IS INTENDED THAT DEMOLITION WORK LEAVE THE ENTIRE AREA FREE OF ABOVE-GRADE ITEMS, INCLUDING PIPIN, CONCRETE PADS, STRUCTURAL SUPPORTS AND MISCELLANEOUS ITEMS. ALL INDICATED TO BE REUSED.
- 7. OWNER MAY WISH TO KEEP DEMOLISHE EQUIPMENT AND MATERIALS. COORDINATE WITH OWNER, AND DISPOSE OF EQUIPMENT AND MATERIALS THAT OWNER DOES NOT REMAIN.
- 8. PREPARE AREA FOR INSTALLATION OFF NEW PLUMBING SYSTEM. REFER TO NEW PLANS AND COORDINATE WITH DEMOLITION WORK.
- 9. ALL PLUMBING FIXTURES WITTH ASSOCIATED PLUMBING PIPING SYSTEM TO BE REMOVED.

# GENERAL CONST. KEYED NOTES:

1) REFER TO ARCHITECTURAL PLANS FOR REMOVAL AND REPLACEMENT OF ARCHITECTURAL FEATURES.

# PLUMBING DEMO KEYED NOTES:

- DEMOLISH EXISTING HOT AND COLD WATER PIPES SERVING CONCESSION BUILDING FIXTURES, CAP AND ABANDON AT PERIMETER WALL.
- 2 REMOVE EXISTING PLUMBING FIXTURES AT THIS APPROXIMATE LOCATION.
- 3 REMOVE EXISTING ELECTRIC WATER HEATER. DEMOLISH HOT AND COLD WATER PIPING SERVING WATER HEATER.
- 4 CAP AND ABANDON EXISTING SANITARY SEWER PIPE.

PLUMBING LEGEND

---- | Wall to be demolished and repaired

REVISIONS BY

GMS ARCHITECTS


1150 Paredes Line Rd.

Brownsville, Texas 78526

(956) 546-0110

Fax (956) 546-0196

S

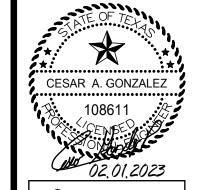


© Copyright 2022 Gomez Mendez Saenz Ind Interior Designers

1126 SOUTH COMMERCE ST. HARLINGEN, TX PHONE: 956-230-3435 TEXAS REGISTERED ENGINEERING FIRM F-15998






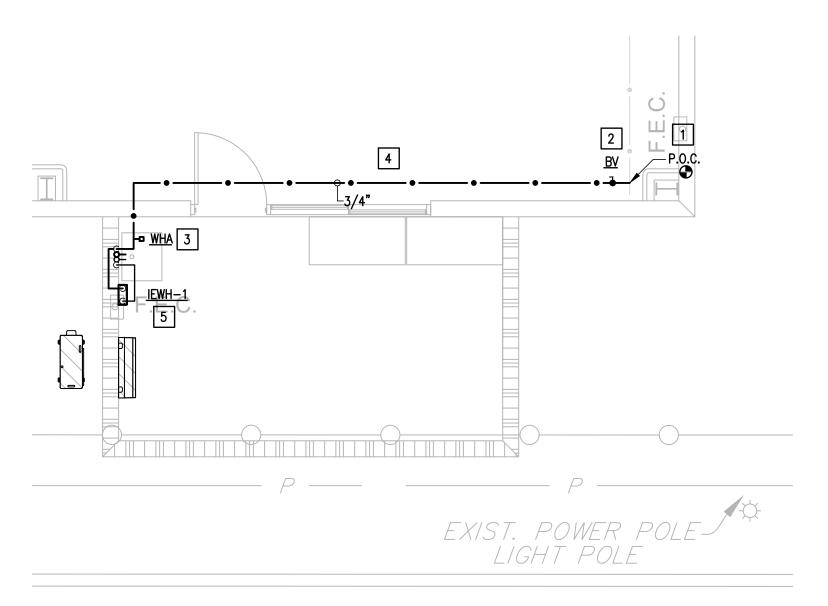

01 NEW CONCESSION PLUMBING PLAN

SCALE: 1/4" = 1'-0"



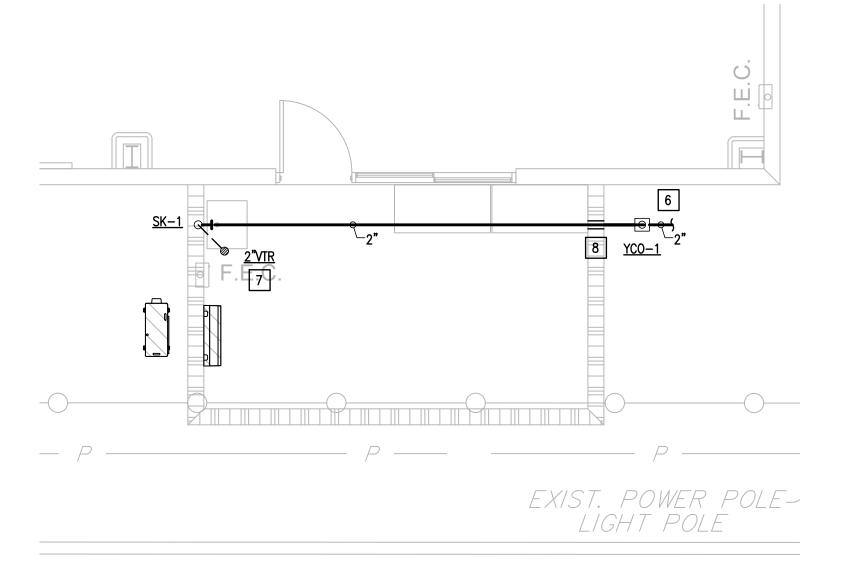

NEW CONCESSION

NEW CONCESSION

SCALE: 1/4" = 1'-0"

NORTH

PLUMBING KEYED NOTES:

1 CONECT NEW 3/4" COLD WATER PIPE TO SERVE NEW SINK AT THIS APROXIMATE POINT.

PROVIDE BRONZE ISOLATION BALL VALVE ABOVE CEILING OR BEHIND WALL. PROVIDE 12"X12" ACCESS PANEL WHERE INSTALLED IN AN INACCESSIBLE AREA. ACCESS PANEL EQUAL TO ACUDOR MODEL UF5000 WITH CYLINDER LOCK AND KEY AND PAINT TO MATCH THE WALL/CEILING. PROVIDE VALVE IDENTIFICATION TAGS AS PER SPECIFICATIONS. (TYPICAL)

PROVIDE BELLOWS TYPE WATER HAMMER ARRESTOR (WHA), MIFAB OR APPROVED EQUAL. INDICATED MODEL (A,B,C,D,E,F) AS PER MIFAB SIZING CHART. PROVIDE 12"X12" ACCESS PANEL WHERE INSTALLED IN AN INACCESSIBLE AREA. ACCESS PANEL EQUAL TO ACUDOR MODEL UF5000 WITH CYLINDER LOCK AND KEY AND PAINT TO MATCH THE WALL/CEILING. (TYPICAL)

PROVIDE PIPING SUPPORT AS PER SPECS AND DETAIL. SEE ASSOCIATED DETAIL ON DETAIL SHEET — TYPICAL.

5 PROVIDE INSTANTANEOUS ELECTRIC WATER HEATER (IEWH-1) AS SCHEDULED.

PROVIDE NEW 2" SANITARY SEWER LINE. PROVIDE ONE WAY YARD CLEANOUT. SEE CIVIL DRAWINGS FOR CONNECTION AND CONTINUATION. REFER TO MEP SITE PLAN FOR LOCATION.

7 PROVIDE 2" VENT UP THROUGH ROOF. (VTR)

8 SLEEVE ALL GRADES BEAMS, FLOOR SLABS AND MASONRY WALL PENETRATIONS PER DETAIL WHETHER SPECIFICALLY INDICATED ON PLANS OR NOT.

TO SERVE NEW SINK AT THIS




REVISIONS BY

GMS ARCHITECTS

1150 Paredes Line Rd. Brownsville, Texas 78526 (956) 546-0110 Fax (956) 546-0196

> CAMERON COUNTY PARKS ANTA ROSA PARK IMPROVEMENTS PHASE II



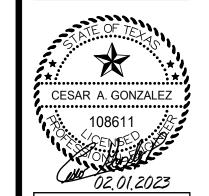

© Copyright 2022
Gomez Mendez Saenz Inc.
Architects-Planners
Interior Designers

Date:
FEBRUARY 01, 2022
Scale:
As Noted
Project Architect:
Roan G. Gomez, AIA
Drawn By:

Sheet: P3 1

1126 SOUTH COMMERCE ST. HARLINGEN, TX PHONE: 956-230-3435 TEXAS REGISTERED ENGINEERING FIRM F-15998

PLUMBING FIXTURE SCHEDULE										
Project: S	anta Rosa Park Improvements Phas	e II								
	MANUFACTURER &			CO	NNECTIO	ONS				
MARK	MODEL NUMBER	DESCRIPTION	WASTE	VENT	CW	HW	NOTES	REMARKS		
SK-1	ELKAY SS8124 ELKAY #LK940GN05T4H 0.5 GPM AERATOR LK335 DRAIN TRUEBRO KIT MIXING VALVE LEONARD #270-LF-BRKT	27" X 27-1/2" X 14" SINGLE COMPARTMENT SCULLERY SINK, 14 GAUGE TYPE 304 STAINLESS STEEL WITH A BUFFED SATIN FINISH, SINK SUPPORTED BY (4) 16 GAUGE STAINLESS STEEL, 1-5/8" TUBULAR LEGS WITH BULLET SHAPED FEET ADJUSTAB LE UP TO 1", BACK MOUNTED INSTALLATION WITH 4" ON CENTER HOLES, REAR CENTER DRAIN. TWO HANDLE BACK MOUNT GOOSE NECK FAUCET. 3.5" DRAIN WITH CUP STRAINER, 1-1/2" 17 GAUGE CHROME PLATED TAILPIECE AND P-TRAP WITH CLEANOUT AND CHROME PLATED SUPPLY STOPS WITH STAINLESS STEEL FLEXIBLE CONNECTORS. POINT-OF-USE THERMOSTATIC VALVE. SET HOT WATER TEMPERATURE AT NO MORE THAN 105 DEGREES FAHRENHEIT.	2"	2"	1/2"	1/2"	1,2	SEE ARCHITECTURAL		

1. PROVIDE TRUEBRO LAVATORY GUARD MODEL #103 E-Z COLOR WHITE. COVER SHALL BE SECURED WITH SNAP-SLIP FLUSH REUSABLE FASTENERS.

2. PROVIDE OFFSET TAILPIECE FOR ALL ADA SINKS.

INSTA	INSTANTANEOUS ELECTRIC WATER HEATER SCHEDULE											
Project: Sa	Project: Santa Rosa Park Improvements Phase II											
		MINIMUM	DEGREE RISE AT	ELECTRICAL		DIMENSIONS	MANUFACTURER					
MARK	LOCATION	FLOW RATE	FLOW RATE	V/PH	KW	LENGTH X WIDTH	& MODEL NUMBER	NOTES				
IEWH-1	NEW CONCESSION	0.35	73°	208V / 1PH	13	10-5/8"X4-1/2"	CHRONOMITE R-63L	1,2				

1. MANUFACTURER & MODEL NUMBER ARE "OR APPROVED EQUAL".


2. SET TEMPERATURE AT 110 DEGREE.

PLUMBING SYMBOLS LEGEND									
<b>•</b>	COLD WATER SUPPLY	wco ⊦—	WALL CLEANOUT						
	HOT WATER SUPPLY	$\rightarrow \bowtie$	*GATE VALVE (GV)						
	TO BE DEMOLISHED	•	*BALL VALVE (BV)						
	SOIL & WASTE LINE - ENLARGED PLANS	*	VALVE IN RISER TYPE AS NOTED						
	VENT LINE - ENLARGED PLANS	WC	WATER CLOSET						
· · · · · · · · · · · · · · · · · · ·	EXISTING COLD WATER LINE	UR	URINAL						
AV	ACID VENT LINE - ENLARGED PLANS	L	LAVATORY						
——-F——	FIRE SPRINKLER LINE	SK	SINK						
FCO( <del>0)</del>	FLOOR CLEANOUT	EDF	ELECTRIC DRINKING FOUNTAIN						
FCO-2	FLOOR CLEANOUT - 2 WAY	MSB	MOP SERVICE BASIN						
FD 🚳 C FD 🎇	FLOOR DRAIN (FD) WITH DEEP SEAL TRA	AP EESHR	EMERGENCY EYE/SHOWER						
HD∝	HUB DRAIN WITH DEEP SEAL TRAP	TP	TRAP PRIMER						
<b>a</b>	FLOOR SINK	EWH	ELECTRIC WATER HEATER						
YCO 🔾	YARD CLEANOUT	VTR	VENT THRU ROOF						
YCO-2	YARD CLEANOUT - 2 WAY	СО	CLEANOUT						
wн <del>-</del> ф	WALL HYDRANT	A.F.F.	ABOVE FINISH FLOOR						
<b>⊖</b>	TRAP PRIMER	ADT	ACID DILUTION TANK						
7	*WATER HAMMER ARRESTOR (WHA)	GT	GREASE TRAP						


<sup>\*</sup> PROVIDE 12"x12" ACCESS PANEL WHERE INSTALLED IN AN INACCESSIBLE AREA.


# GENERAL NOTES: (APPLY TO ALL PLUMBING SHEETS)


- 1. ALL PLUMBING WORK SHALL BE IN COMPLIANCE WITH ALL APPLICABLE CODES AS ADAPTED AND AMENDED BY THE INSPECTING AUTHORITIES.
- 2. DRAWING IS DIAGRAMMATIC ONLY. CONTRACTOR SHALL COORDINATE EXACT LOCATIONS OF PIPING, DEVICES AND EQUIPMENT WITH BUILDING ELEMENTS AND THE WORK OF OTHER TRADES.
- 3. ALL PLUMBING WORK SHALL BE INSTALLED SO AS TO AVOID CONFLICT WITH THE WORK OF OTHER TRADES. COORDINATE WITH MECHANICAL, ELECTRICAL AND STRUCTURAL FOR PROPER CLEARANCES.
- 4. REFER TO ARCHITECTURAL DRAWINGS AND SPECIFICATIONS FOR PHASING AND SEQUENCE OF CONSTRUCTION WORK.
- 5. COORDINATE WORK AMONG ALL DISCIPLINES. IT IS NOT THE INTENT OF THESE DOCUMENTS TO DICTATE WHO MUST DO THE WORK. ALL WORK SHOWN IS THE RESPONSIBILITY OF THE PRIME CONTRACTOR.
- 6. SLEEVE ALL OUTSIDE WALLS, FOUNDATION GRADE BEAMS, INTERIOR WALL PENETRATIONS, AND FIRE SEAL ALL PENETRATION THROUGH FIRE WALLS AND FLOORS WHETHER SHOWN ON PLANS OR NOT.
- 7. PROVIDE MINIMUM 15' OF SEPARATION BETWEEN HVAC INTAKES AND VENT THRU ROOFS.
- 8. RECORD INVERT ELEVATIONS OF ALL YARD CLEAN OUT (YCO) ON "AS-BUILT" DRAWINGS.
- 9. PROVIDE SHUT-OFF VALVES (STOPS) ON ALL ROUGH-INS TO FIXTURES AND EQUIPMENTS.
- 10. PROVIDE WATER HAMMER ARRESTORS AS INDICATED ON THE DRAWINGS. AIR CHAMBERS NOT AN APPROVED SUBSTITUTE.
- 11. PROVIDE ANY BACKFLOW PREVENTION DEVICE REQUIRED BY CODE OR LOCAL AUTHORITIES. CONTRACTOR SHALL VERIFY THIS WITH CITY AND LOCAL AGENCIES AND INCLUDE COST IN BID. CONTRACTOR TO HAVE BACK FLOWS CERTIFIED.
- 12. REFER TO PLUMBING FIXTURE ROUGH-IN SCHEDULE FOR INDIVIDUAL PIPE CONNECTIONS TO FIXTURES.
- 13. PRIOR TO POURING FOUNDATION AND ERECTING WALLS, COORDINATE INSTALLATION OF PLUMBING FIXTURE CARRIERS WITH
- 14. STUDS AT DRY WALLS SHALL NOT BE CUT THRU HORIZONTAL DIRECTION. COORDINATE WITH DRY WALL CONTRACTOR.
- 15. CONTRACTOR SHALL NOT CUT ANY EXTERIOR WALL STUD.

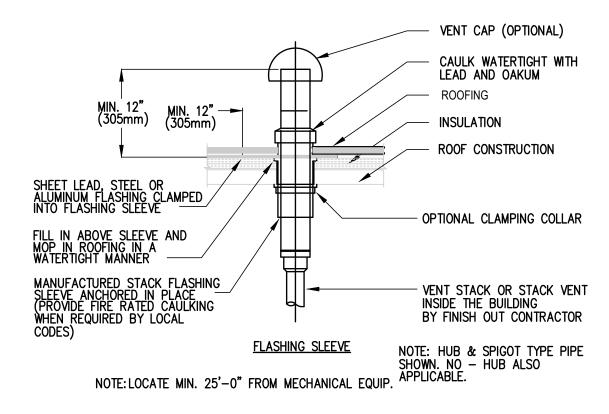



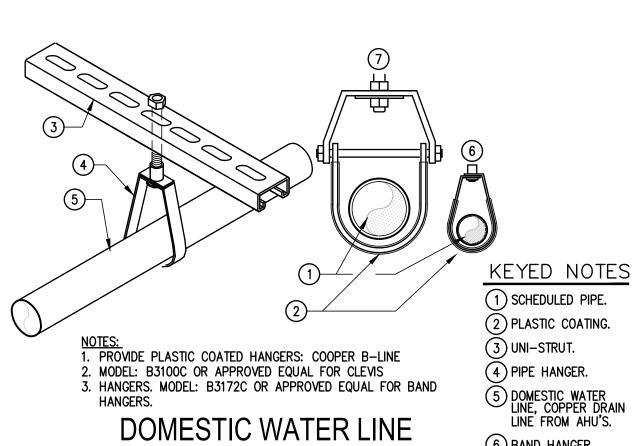

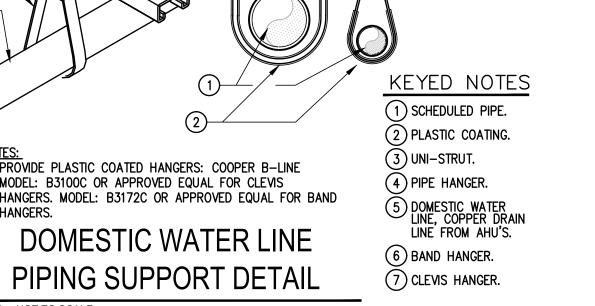


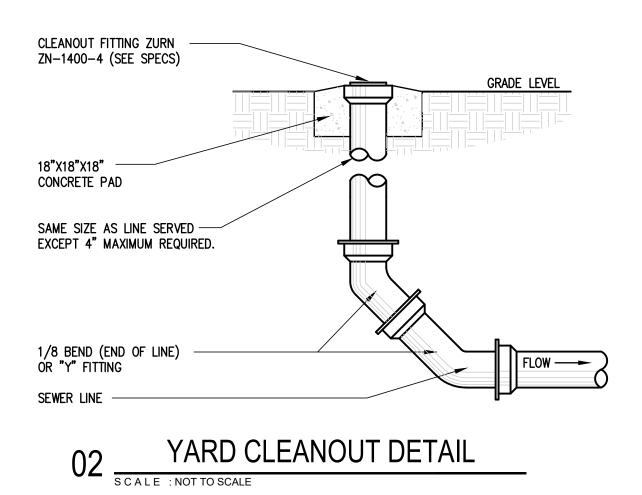





1126 SOUTH COMMERCE ST.
HARLINGEN, TX
PHONE: 956-230-3435
TEXAS REGISTERED
ENGINEERING FIRM
F-15998

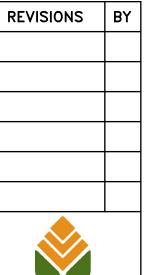






AMER OSA PA



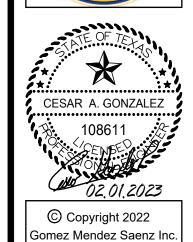

Architects-Planners Interior Designers